## **GENERAL NOTES:**

1. ELEVATIONS SHOWN ON THESE PLANS ARE BASED ON A BOUNDARY & TOPOGRAPHIC SURVEY BY LANGSTON SURVEYING AND MAPPING, LLC (850) 491-3880.

2. SURVEY DATUM - NAVD 88

3. AT THE PRE CONSTRUCTION MEETING THE CONTRACTOR SHALL DESIGNATE A REPRESENTATIVE WHO SHALL BE CAPABLE OF BEING REACHED 24 HOURS A DAY, 7 DAYS A WEEK.

4. ALL EXISTING UTILITIES MAY NOT HAVE BEEN LOCATED. IT IS THE CONTRACTOR'S RESPONSIBILITY TO VERIFY THE LOCATION OF ALL EXISTING UTILITIES PRIOR TO THE COMMENCEMENT OF CONSTRUCTION ACTIVITIES AND PROVIDE FOR PROTECTION OF EXISTING UTILITIES DURING CONSTRUCTION. THE CONTRACTOR SHALL NOTIFY SUNSHINE ONE, CALL (1-800-432-4770), 48 HOURS PRIOR TO COMMENCEMENT OF CONSTRUCTION.

5. PIPE LENGTHS SHOWN INCLUDE THE MITERED END SECTIONS.

6. UNLESS OTHERWISE NOTED, ALL AREAS DISTURBED BY CONSTRUCTION SHALL BE SEEDED AND MULCHED.

7. UNLESS OTHERWISE INDICATED OR MODIFIED ON THE PLANS ALL ROADWAY AND DRAINAGE CONSTRUCTION SHALL BE IN ACCORDANCE WITH FDOT STANDARD SPECIFICATIONS FOR ROAD AND BRIDGE CONSTRUCTION, 2010, SUPPLEMENTS AND SPECIAL PROVISIONS THERETO.

8. MINIMUM COMPACTION FOR FILL SECTIONS SHALL BE 95% MODIFIED PROCTOR. SOIL UNDER ALL STRUCTURES AND PAVED AREAS (MIN. 18" DEPTH) SHALL BE COMPACTED TO 95% MODIFIED PROCTO STRUCTURAL FILL SOILS SHOULD BE PLACED IN MAXIMUM 12 INCH LIFTS AND COMPACTED TO A MINIMUM SOIL DENSITY OF 95% MODIFIED PROCTOR. THE TOP 12 INCHES OF SUBGRADE SHOULD COMPACTED TO A MINIMUM SOIL DENSITY OF 98% MODIFIED PROCTOR. BORROW MATERIAL, IF REOUIRED, IS TO BE PROVIDED BY THE CONTRACTOR AND HAVE A MINIMUM LBR VALUE OF 40. TOPSOIL IS TO BE STRIPPED AND STOCKPILED. FOLLOWING FINAL GRADING, PLACE STOCKPILED TOPSOIL, AS NEEDED OVER DISTURBED AREA

9. WHERE REFERENCE IS MADE TO STANDARD INDEX OR DETAIL, THE FDOT ROADWAY AND TRAFFIC DESIGN STANDARDS, 2014, SHALL BE USED AS IF A PART OF THIS PLAN. FOR DESIGN STANDARD MODIFICATIONS CLICK ON "DESIGN STANDARDS" AT THE FOLLOWING WEB SITE: http://www.dot.state.fl.us/rddesign/

10. THE CONTRACTOR SHALL COMPLY WITH ALL LOCAL, STATE, AND FEDERAL REGULATIONS. SEDIMENT CONTROL DEVICES SHOWN ON THE PLANS ARE MINIMUM REQUIREMENTS. ADDITIONAL SEDIMENT CONTROLS MAY BE REQUIRED BY THE LOCAL INSPECTOR TO PREVENT SEDIMENTS FROM LEAVING THE SITE. THESE ADDITIONAL SEDIMENT CONTROLS ARE THE CONTRACTOR'S RESPONSIBILITY. ADDITIONALLY, STORMWATER RUNOFF IS TO BE CONTROLLED DURING CONSTRUCTION AS TO NOT DETRIMENTALLY AFFECT ADJACENT PROPERTIES

COMPACTION, ASPHALT, AND BASE IN PLACE TESTING SHALL BE PERFORMED BY A STATE OF FLORIDA REGISTERED GEOTECHNICAL ENGINEER AT THE EXPENSE OF THE CONTRACTOR. DENSITIES FO FILL MATERIAL, BASE MATERIAL, ASPHALT TESTING, AND OTHER AREAS WITH REQUIRED PERCENT OF COMPACTION SHALL BE TAKEN AT THE RATE OF ONE PER LIFT (6" MAXIMUM COMPACTED THICKNESS) PER 300 SQUARE YARDS. THE CONTRACTOR SHALL COORDINATE TESTING WITH THE ENGINEER TO INSURE COMPLIANCE WITH THE ABOVE REQUIREMENTS.

THE CONTRACTOR SHALL PROVIDE A DESIGN MIX FOR THE ASPHALT INDICATED AND IT SHALL B SIGNED BY A PROFESSIONAL ENGINEER CERTIFIED BY FDOT FOR DESIGN OF ASPHALT MIXES. THE MINIMUM COMPACTION FOR ASPHALT SHALL BE 95% OF THE MAXIMUM LABORATORY DENSITY. THE FINISHED SURFACE SHALL BE SMOOTH AND FREE OF TEARS. ANY NONCONFORMING SURFACE SHALL BE SAW CUT AT THE LIMITS OF NONCONFORMITY IN A STRAIGHT LINE AND REMOVED AND REPLACED.

13. THE CONTRACTOR SHALL SUBMIT A POST-CONSTRUCTION CERTIFICATION AND REPRODUCIBLE RECORD DRAWINGS TO THE ENGINEER PRIOR TO INSPECTION AND ACCEPTANCE. THE RECORD DRAWINGS SHALL BE PREPARED AND CERTIFIED BY A PROFESSIONAL LAND SURVEYOR.

14. THE CONTRACTOR SHALL NOTIFY THE ENGINEER OF THE DISCOVERY OF ANY ERRORS AND/OR OMISSIONS IN THE PLANS OR SPECIFICATIONS. THE ENGINEER WILL MAKE SUCH CORRECTIONS AND INTERPOLATIONS AS DEEMED NECESSARY REFLECTING THE ACTUAL SPIRIT AND INTENT OF THE PLANS AND SPECIFICATIONS.

15. SUBDIVISION OF THE PROPERTY IS REQUIRED AS PROPOSED AND DEPICTED. THE RESULTING PARCEL SIZE SHALL NOT EXCEED TWO (2) ACRES PURSUANT TO THE POLICY 3.1.2 OF THE LAND USE ELEMENT OF THE COMPREHENSIVE PLAN. SUBDIVISION MAY ONLY COMMENCE UPON APPROVAL OF THE PROPOSED SITE PLAN.

16. THE FOLLOWING PERMITS/APPROVALS HAVE OR WILL BE OBTAINED FOR THIS PROJECT:

A. LEON COUNTY ENVIRONMENTAL PERMIT

B. NWFWMD INDIVIDUAL ENVIRONMENTAL RESOURCE PERMIT C. NPDES PERMIT

17. UPON ROUGH GRADING (WITHIN 3 INCHES), THE CONTRACTOR SHALL STOP WORK TO ALLOW FOR INSTALLATION OF UTILITIES. THE CONTRACTOR SHALL CERTIFY THAT THE SITE IS WITHIN THIS TOLERANCE.

18. THE CONSTRUCTION SITE ENTRANCE SHALL BE MAINTAINED IN A CONDITION WHICH WILL PREVENT TRACKING OR DIRECT FLOW OF MUD AND SEDIMENTS ONTO THE STREETS. ANY SEDIMENTS OR MUD SPILLED, DROPPED, WASHED OR TRACKED FROM VEHICLES ONTO ROADWAYS SHALL BE RECOVERED AND CLEANED IMMEDIATELY.

19. THE CONTRACTOR SHALL CONFINE ALL WORK WITHIN THE BOUNDARIES, EASEMENTS AND RIGHT OF WAY OWNED BY THE DEVELOPER, THE STATE OR THE COUNTY. NO TRESPASSING IS ALLOWED.

20. IF DURING CONSTRUCTION OR OPERATION OF THE STORMWATER MANAGEMENT SYSTEM, A STRUCTURAL FAILURE IS OBSERVED THAT HAS THE POTENTIAL TO CAUSE THE DIRECT DISCHARGE OF SURFACE WATER INTO THE FLORIDA AQUIFER SYSTEM, CORRECTIVE ACTIONS DESIGNED OR APPROVED BY A REGISTERED PROFESSIONAL SHALL BE TAKEN AS SOON AS POSSIBLE TO CORRECT THE FAILURE. A REPORT PREPARED BY A REGISTERED PROFESSIONAL MUST BE PROVIDED AS SOON AS PRACTICAL TO THE DEPARTMENT FOR REVIEW AND APPROVAL THAT PROVIDES REASONABLE ASSURANCE THAT THE BREACH WILL BE PERMANENTLY CORRECTED.

21. STABILIZATION MEASURES SHALL BE INITIATED FOR EROSION AND SEDIMENT CONTROL ON DISTURBED AREAS AS SOON AS PRACTICAL IN PORTIONS OF THE SITE WHERE CONSTRUCTION ACTIVITIES HAVE TEMPORARILY OR PERMANENTLY CEASED, BUT IN NO CASE MORE THAN THREE DAYS AFTER THE CONSTRUCTION ACTIVITY IN THAT PORTION OF THE SITE HAS TEMPORARILY OR PERMANENTLY CEASED.

22. AT LEAST 48 HOURS PRIOR TO CONSTRUCTION, THE CONTRACTOR IS TO COORDINATE WITH THE OWNER TO SUBMIT THE CONSTRUCTION COMMENCEMENT NOTICE FORM 62-346.900(3) TO THE NWFWMD. ALSO, THE AS-BUILT CERTIFICATION BY A REGISTERED PROFESSIONAL FORM 62-346.900(4) SHALL BE SUBMITTED TO THE NWFWMD WITHIN 30 DAYS AFTER WORK IS COMPLETED.


23. MAINTENANCE OF TRAFFIC FOR CONSTRUCTION OF DRIVEWAYS SHALL BE IN ACCORDANCE WITH F.D.O.T. STANDARD INDEX 600'S

24. CONTRACTOR IS REQUIRED TO REVIEW THE COMPLETE NWFWMD PERMIT PRIOR TO CONSTRUCTION COMMENCEMENT.

25. A COPY OF THE NWFWMD PERMIT IS TO BE KEPT ON-SITE

26. AN 8.5"X 11" WEATHER RESISTANT SIGN, INCLUDING THE NWFWMD PERMIT NUMBER SHALL BE PLACED ON THE PROPERTY FACING THE ROAD.

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# SHEET INDEX

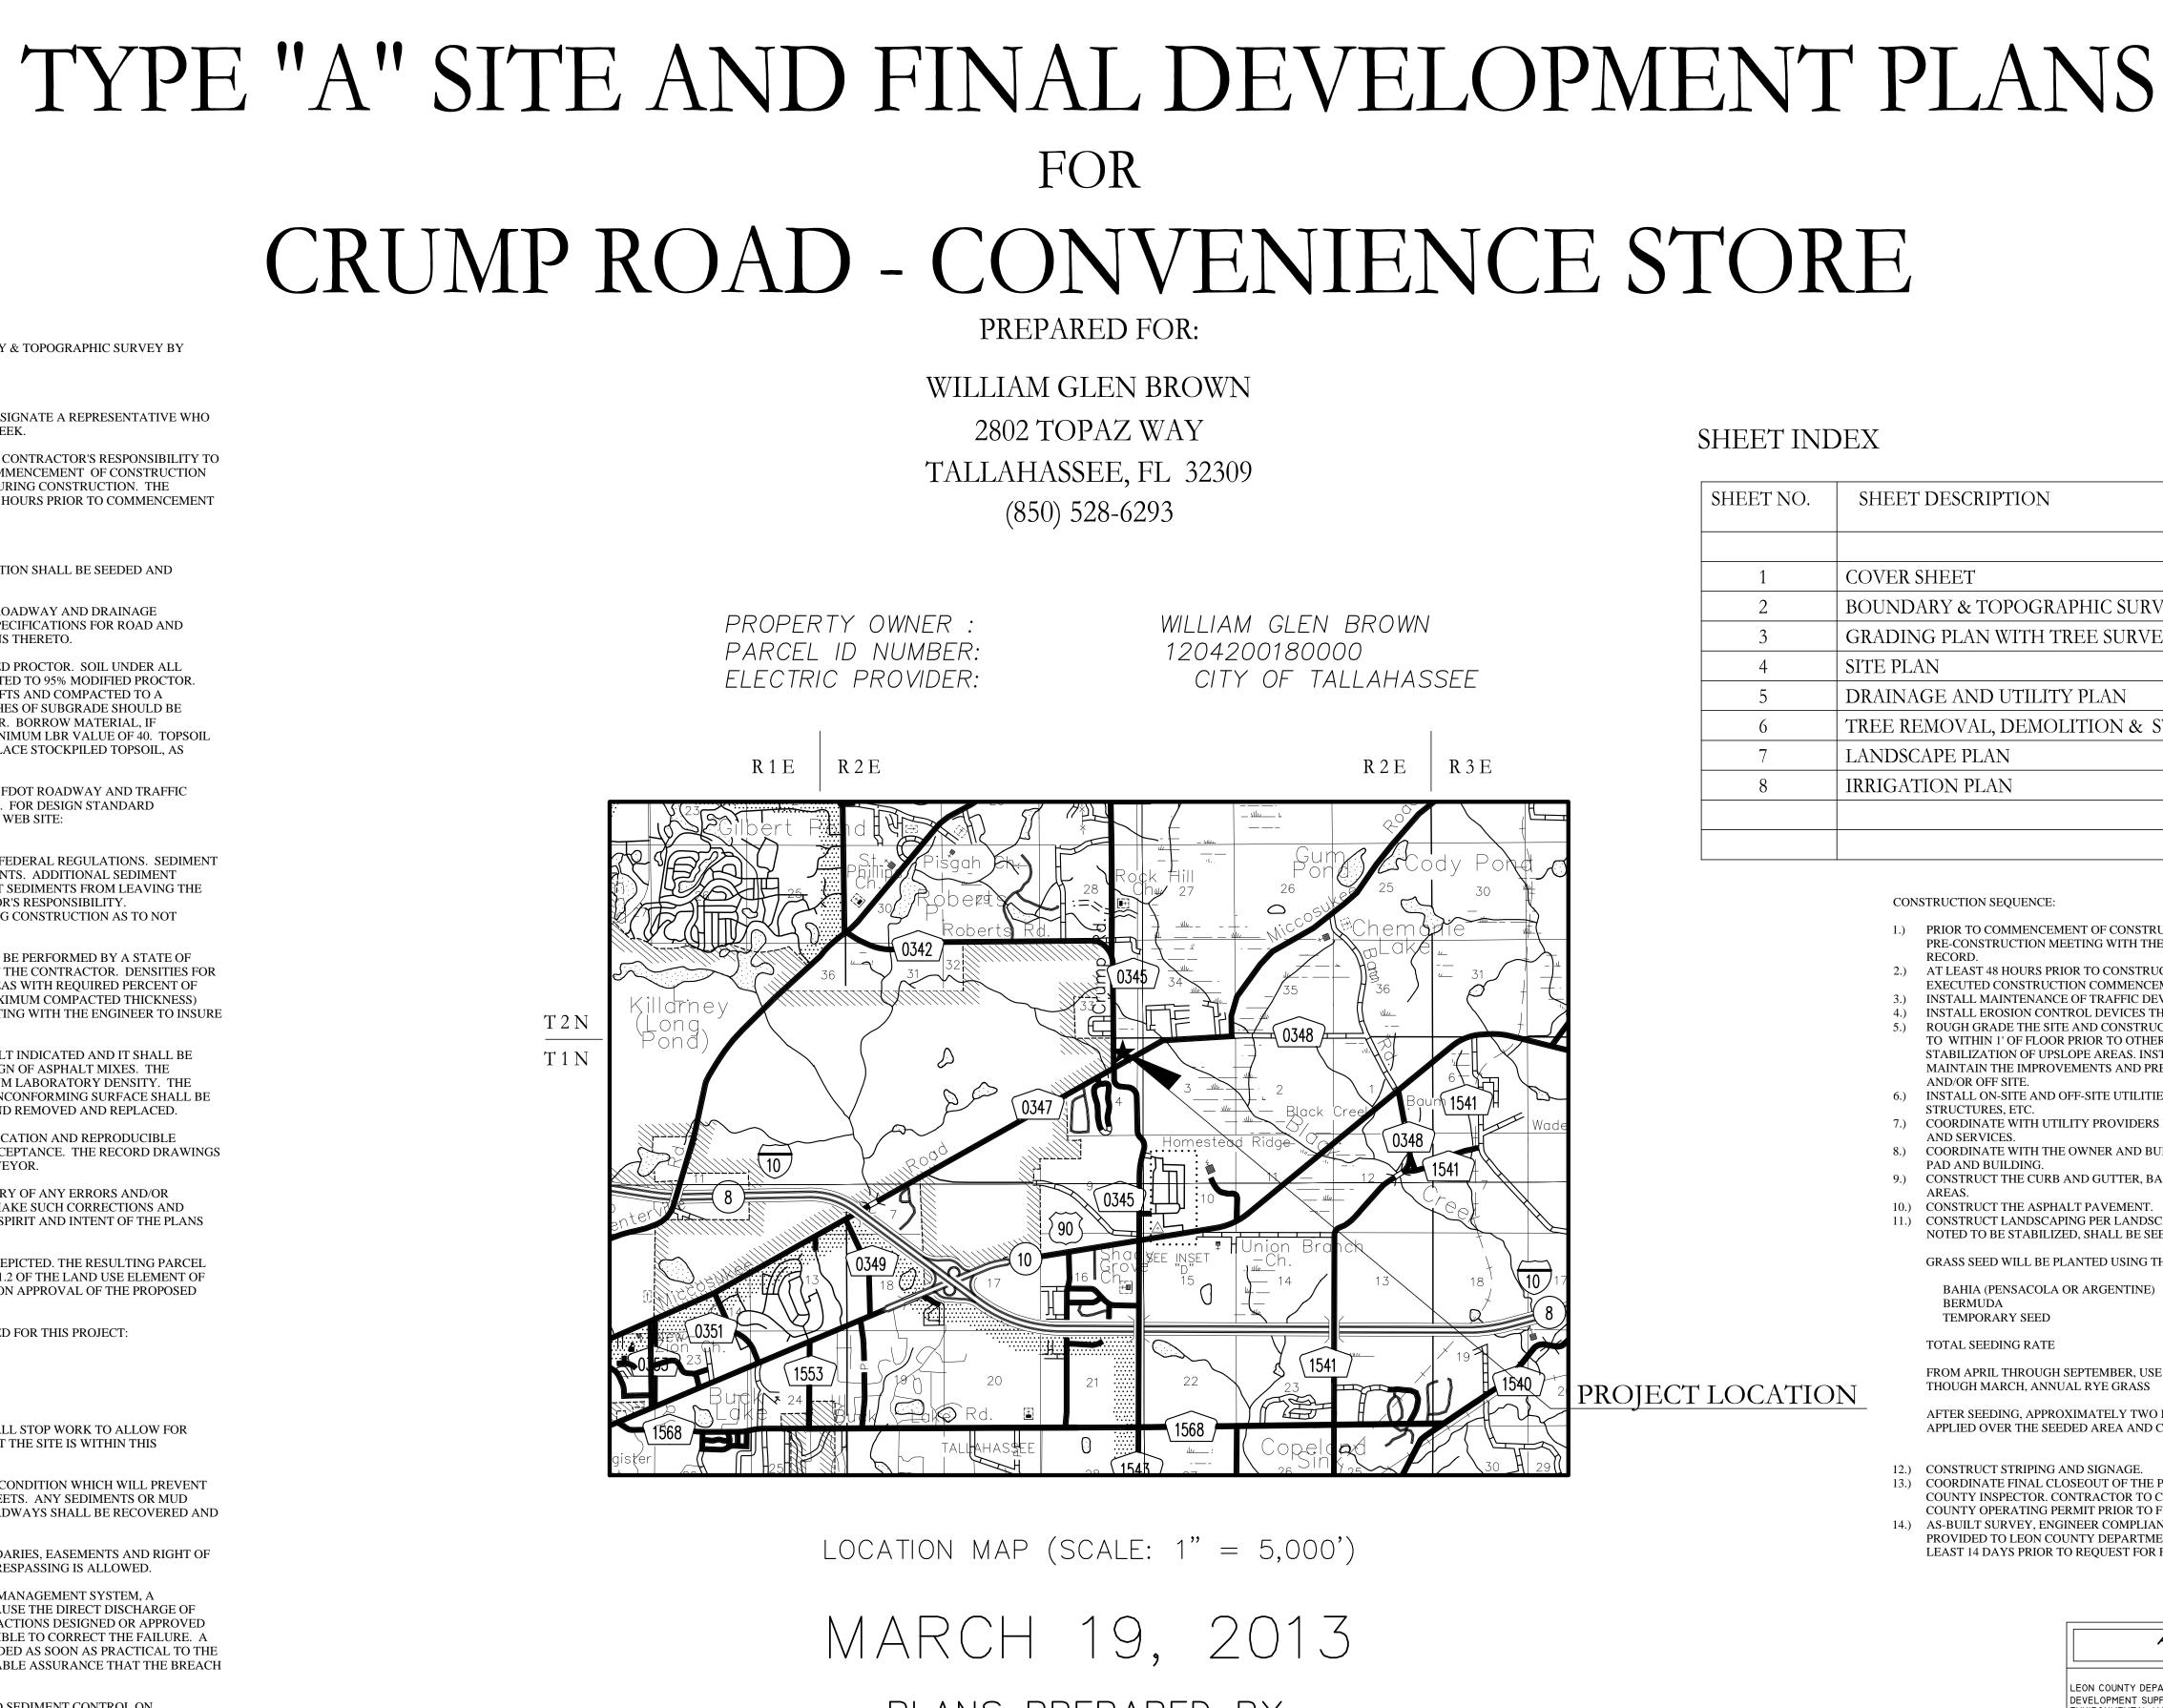SHEET NO.	SHEET DESCRIPTION	DATE	REVISION
1	COVER SHEET	3/19/14	
2	BOUNDARY & TOPOGRAPHIC SURVEY	3/19/14	
3	GRADING PLAN WITH TREE SURVEY	3/19/14	
4	SITE PLAN	3/19/14	
5	DRAINAGE AND UTILITY PLAN	3/19/14	
6	TREE REMOVAL, DEMOLITION & SWPP PLAN	3/19/14	
7	LANDSCAPE PLAN	3/19/14	
8	IRRIGATION PLAN	3/19/14	

CONSTRUCTION SEQUENCE:

- 1.) PRIOR TO COMMENCEMENT OF CONSTRUCTION, THE CONTRACTOR SHALL COORDINATE A PRE-CONSTRUCTION MEETING WITH THE OWNER LEON COUNTY INSPECTOR AND ENGINEER OF
- RECORD.
- 2.) AT LEAST 48 HOURS PRIOR TO CONSTRUCTION THE OWNER IS REQUIRED TO SUBMIT A FULLY EXECUTED CONSTRUCTION COMMENCEMENT NOTICE FORM 62-346,900(3) TO THE NWFWMD
- INSTALL MAINTENANCE OF TRAFFIC DEVICES PER FDOT INDEX #600'S

4.) INSTALL EROSION CONTROL DEVICES THEN CLEAR AND GRUB THE SITE 5.) ROUGH GRADE THE SITE AND CONSTRUCT THE SWMF AS SHOWN ON THE PLANS. INITIALLY GRADE SWMF TO WITHIN 1' OF FLOOR PRIOR TO OTHER CONSTRUCTION, AND ACHIEVE FINAL GRADE UPON STABILIZATION OF UPSLOPE AREAS. INSTALL ADDITIONAL EROSION CONTROLS AS NECESSARY TO MAINTAIN THE IMPROVEMENTS AND PREVENT SEDIMENTS FROM WASHING INTO THE DETENTION POND AND/OR OFF SITE.

6.) INSTALL ON-SITE AND OFF-SITE UTILITIES INCLUDING STORMWATER PIPES, INLETS, OUTFALL

- STRUCTURES, ETC. 7.) COORDINATE WITH UTILITY PROVIDERS REGARDING INSTALLATION OF SERVICE LINES, CONDUIT,
- AND SERVICES. 8.) COORDINATE WITH THE OWNER AND BUILDING CONTRACTOR ON CONSTRUCTION OF THE BUILDING
- PAD AND BUILDING.
- 9.) CONSTRUCT THE CURB AND GUTTER, BASE, FINE GRADE, AND STABILIZE (SOD) THE DISTURBED AREAS.
- 10.) CONSTRUCT THE ASPHALT PAVEMENT.
- 11.) CONSTRUCT LANDSCAPING PER LANDSCAPE PLAN. ALL REMAINING DISTURBED AREAS, NOT OTHERWISE NOTED TO BE STABILIZED, SHALL BE SEEDED, MULCHED AND FERTILIZED.

GRASS SEED WILL BE PLANTED USING THE FOLLOWING BLEND.

BAHIA (PENSACOLA OR ARGENTINE)	30 POUNDS/ACRE
BERMUDA	30 POUNDS/ACRE
TEMPORARY SEED	30 POUNDS/ACRE
TOTAL SEEDING RATE	90 POUNDS/ACRE

FROM APRIL THROUGH SEPTEMBER, USE BROWN-TOP OR JAPANESE MILLET AND FROM OCTOBER THOUGH MARCH, ANNUAL RYE GRASS


AFTER SEEDING, APPROXIMATELY TWO INCHES (LOOSE THICKNESS) OF MULCH MATERIAL SHALL BE APPLIED OVER THE SEEDED AREA AND CUT INTO THE SOIL.

12.) CONSTRUCT STRIPING AND SIGNAGE.

13.) COORDINATE FINAL CLOSEOUT OF THE PROJECT WITH OWNER, ENGINEER OF RECORD & LEON COUNTY INSPECTOR. CONTRACTOR TO COORDINATE POST CONSTRUCTION CERTIFICATION AND LEON COUNTY OPERATING PERMIT PRIOR TO FINAL INSPECTION MEETING WITH LEON COUNTY INSPECTOR. 14.) AS-BUILT SURVEY, ENGINEER COMPLIANCE STATEMENT AND OPERATING PERMIT APPLICATION SHALL BE

PROVIDED TO LEON COUNTY DEPARTMENT OF DEVELOPMENT SUPPORT & ENVIRONMENTAL MANAGENT AT LEAST 14 DAYS PRIOR TO REQUEST FOR FINAL INSPECTION.

	A P P R O V A L TYPE "A" SITE AND DEVELOPMENT PLAN	
	LEON COUNTY DEPARTMENT OF DEVELOPMENT SUPPORT & ENVIRONMENTAL MANAGEMENT NAME AND TITLE	DATE
		1
	PRELIMINARY NOT FOR CONSTRUCTION	
ATTENTION IS DIREC THAT THESE PLANS N ALTERED IN SIZE BY THIS MUST BE CONSI OBTAINING SCALED	AAY HAVE BEEN REPRODUCTION. DERED WHEN	
	MAR 1 9 2014 Record: Joseph Alday, pe	
LINGUNEER OF P	FLA. LICENSE # 57953	

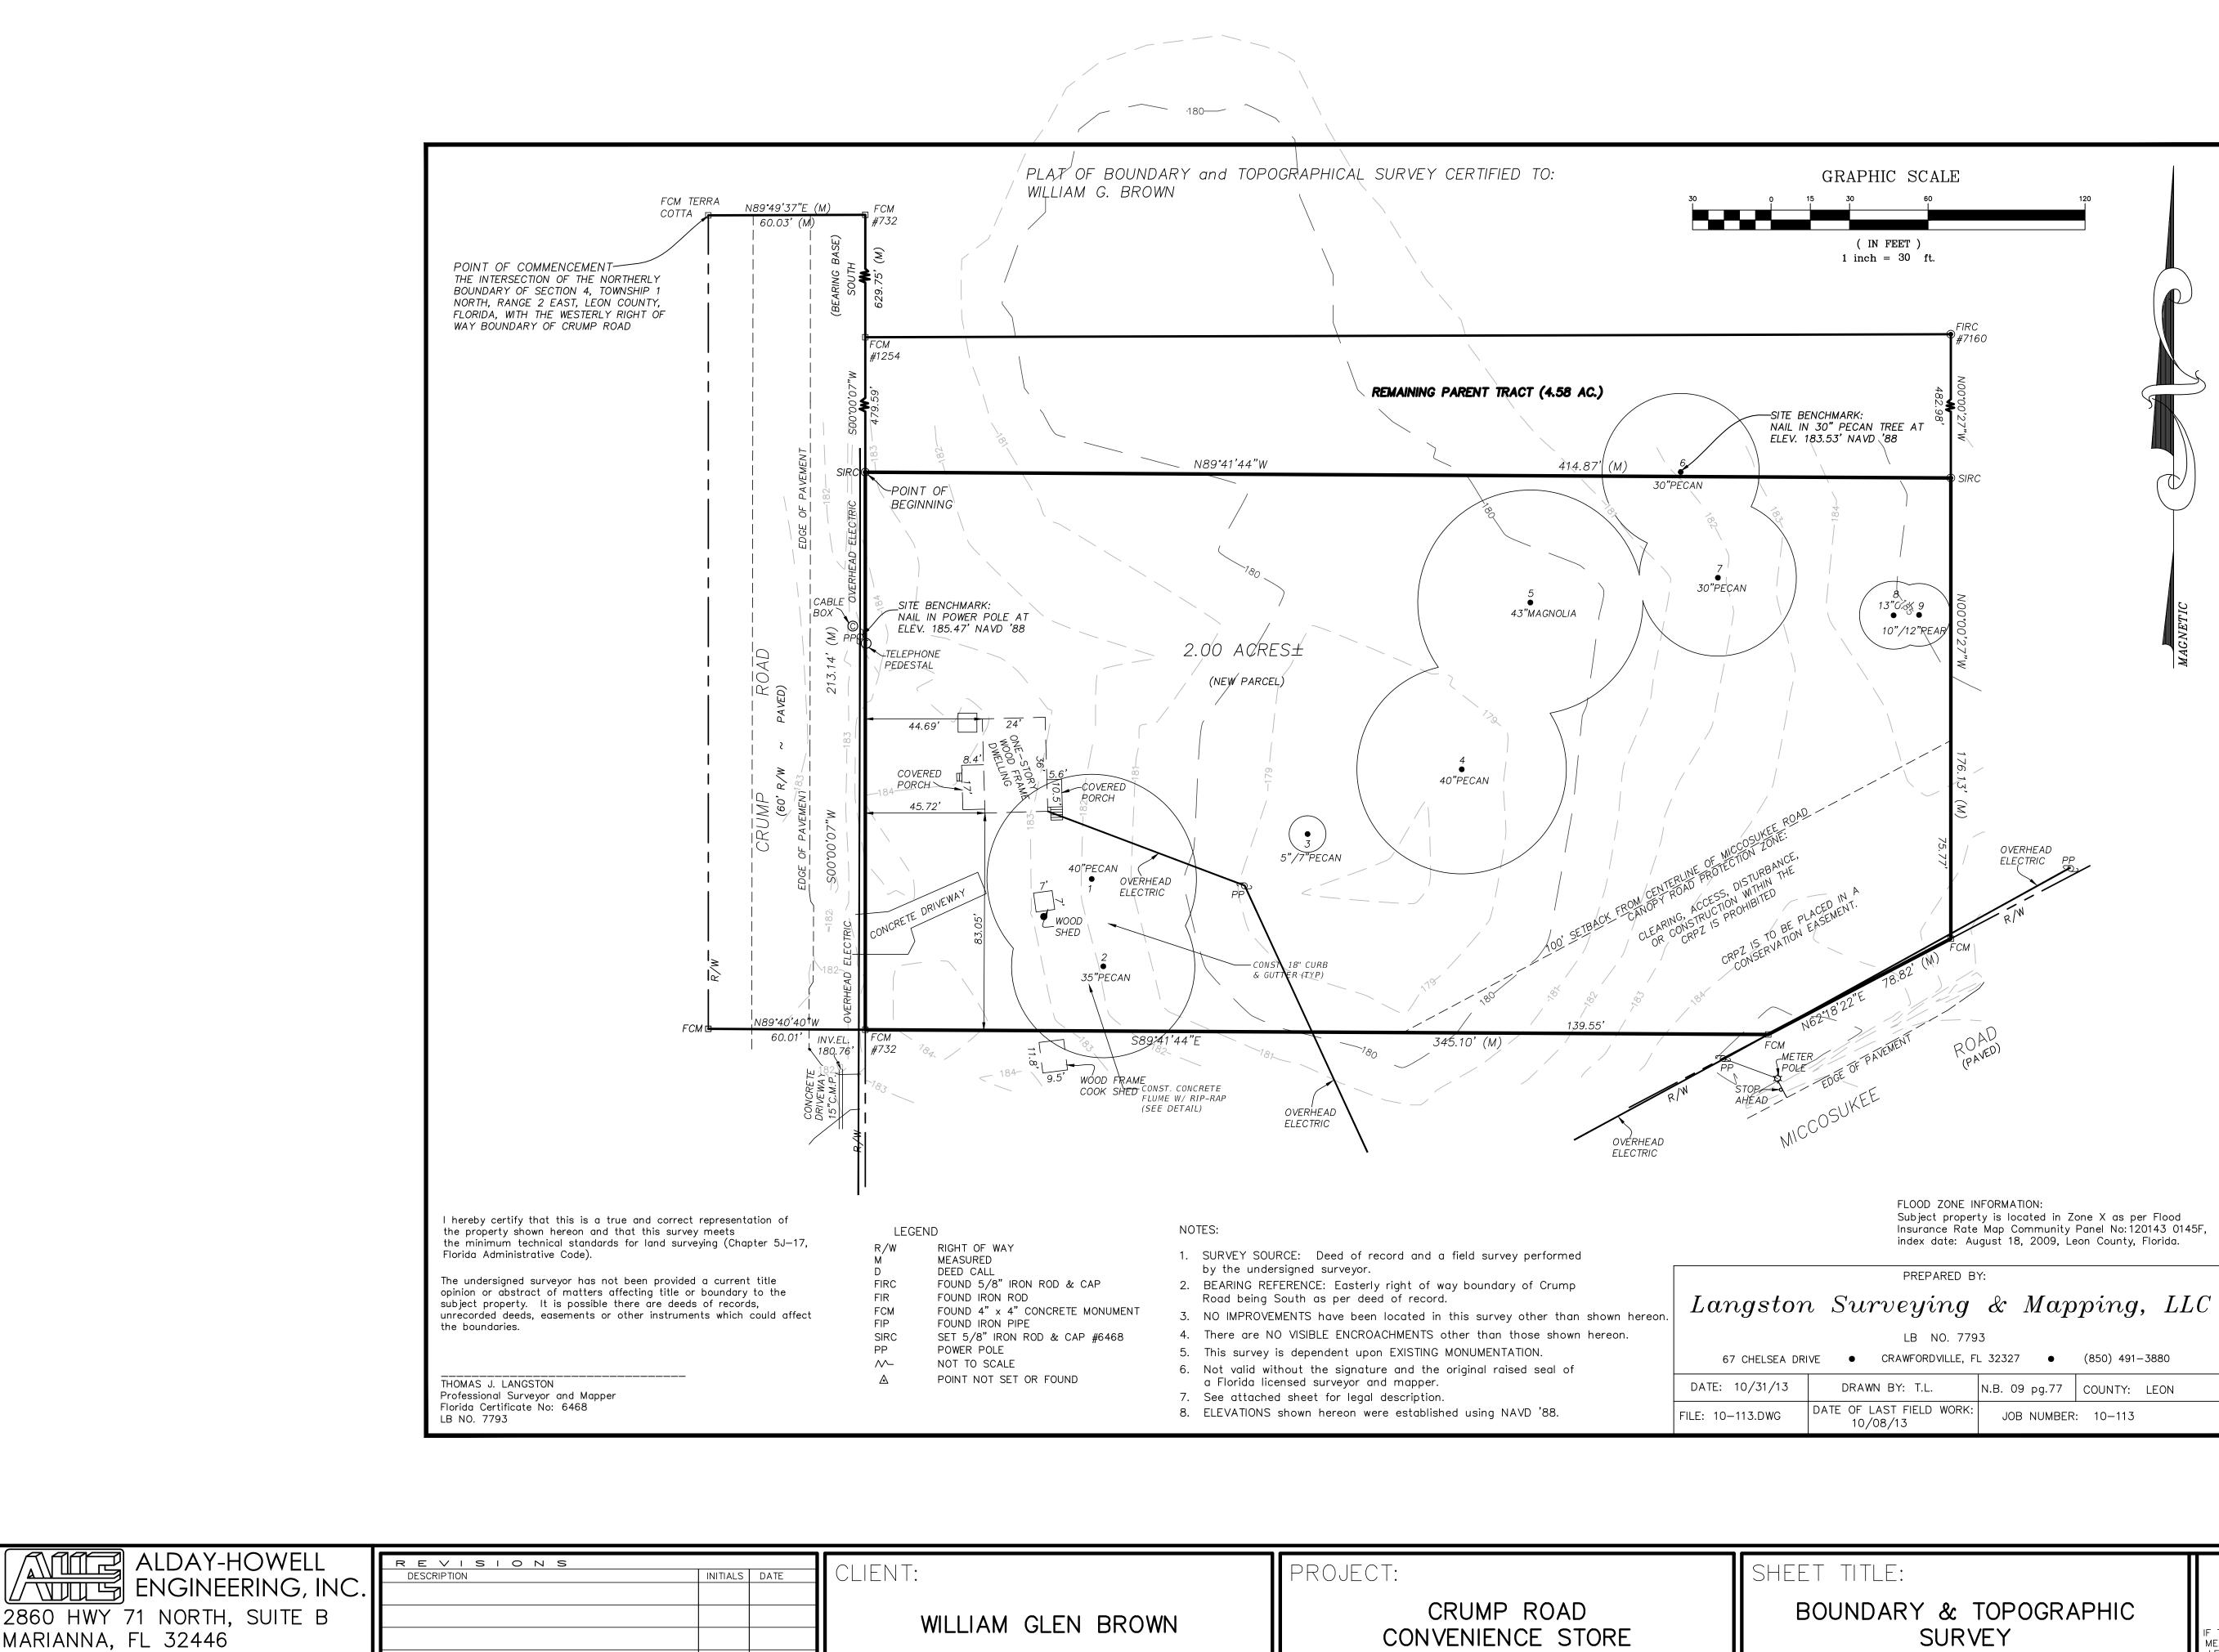


PHONE (850) 526-2040 \* FAX (850) 526-4740

E-MAIL : info@aldayhowell.com FLORIDA CERTIFICATE OF AUTHORIZATION. NO. 26105


\⊤:	PROJECT:	SHEET TIT
WILLIAM GLEN BROWN	CRUMP ROAD CONVENIENCE STORE	BOUND

1" IF THIS LINE DOES NOT MEASURE ONE INCH IN LENGTH, THE SCALES ON THIS DRAWING ARE NOT VALID.

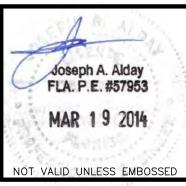


JOB NO. <u>13-034</u> DRAWN BY \_\_\_\_ECW CHECKED BY JAA 3/19/14 DATE SHEET  $\mathcal{O}$ 

PRELIMINARY NOT FOR CONSTRUCTION

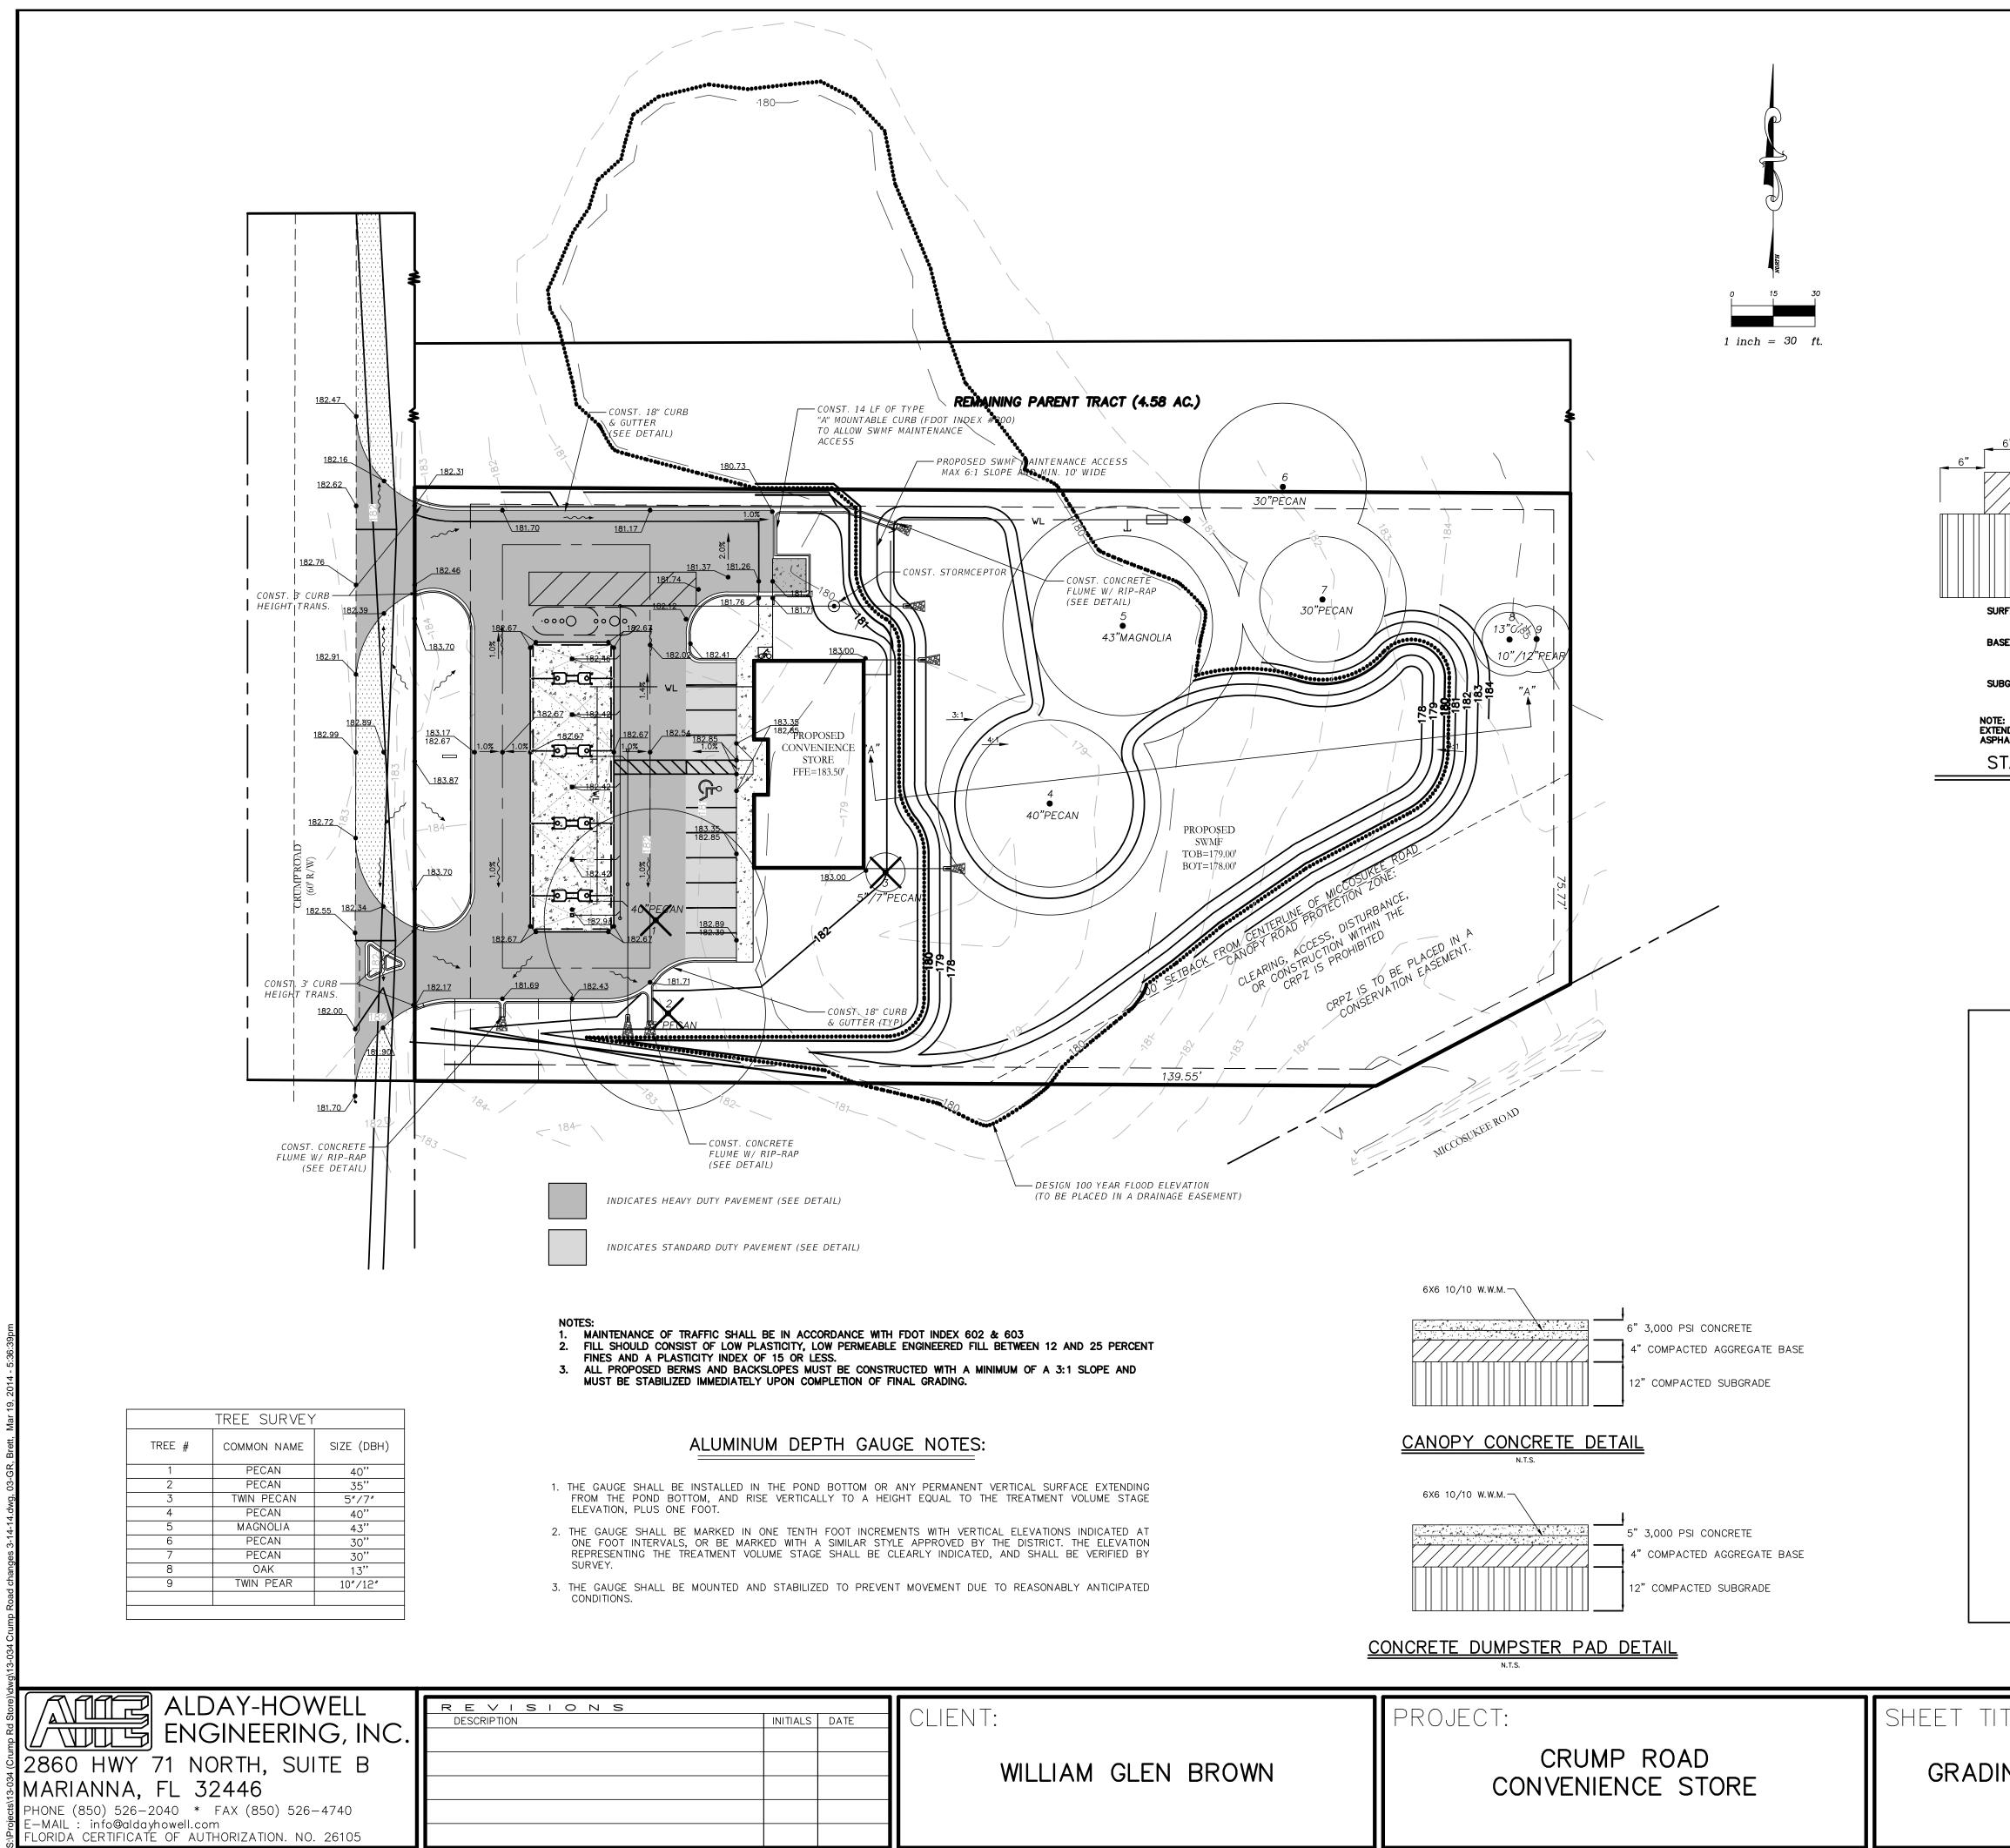

<del></del>	1 <u>/8"/FT.</u>	#3 CONTINUOUS-			
	6X6 10/10 W.W.M.	12"	ASP	HALT PAVEMENT	
M	iote: Sidewalks shall meet ada &	FDOT STANDARDS	6"		
	SIDEWALK DET	-			
"EDGE OF ASPHALT	SURFACE COAF	6"	<u>6"</u>	OF ASPHALT	
	BASE COARSE				
	SUBGRADE				7
ACE COURSE- TYPE SP-9.5 ASPHALTIC C (2" MIN. COMPACTED THICK COURSE- LIMEROCK COMPACTED THIC MIN. LBR 100	NESS)		-	COMPACTED THICKNESS)	
RADE- 12" MIN. COMPACT TO 98% MODIFIE RADE- 12" MIN. COMPACTED THICK TYPE B STABILIZATION. MI (COMPACTED TO 98% MODIFIE	NESS WITH N. LBR 40		(COMPAC IGRADE- 12" MIN. TYPE B S (COMPAC	T TO 98% MODIFIED PROC COMPACTED THICKNESS STABILIZATION. MIN. LBR TED TO 98% MODIFIED PF	WITH 40 ROCTOR)
WHEN ABUTTING TO CURB AND GUTTER SU DELOW CURB FOR FULL WIDTH OF BASE LT TO ABUT CURB AND GUTTER. ANDARD DUTY PAVEM	AND	EXTEN ASPH	WHEN ABUTTING TO CUR ND BELOW CURB FOR FULL ALT TO ABUT CURB AND Y DUTY PAVE	_ WDTH OF BASE AND GUTTER.	
N.T.S.			N.T.S.		
TOP EL. = $180.00'$	` '			Z. SCALE:	
BOTTOM EL. = 178.0		LUME=178.34' 00 YR FLOOD ELEV.=180		. SCALE: 1'	
185					
180			<u>h:</u> ,		
175 0+00.00 EXISTING GI	1+00.00	POND BOTTOM=1	— PROPOSED GRADE <b>21</b> 78.00'	 ⊦00.00	2+50.00
	SWMF				
	OSS SECTION	"A"-"A"			
TO PREVENT UNNECES	SHALL BE KEPT OUT OF THE STO SARY COMPACTION OF THE SOIL.				
CONTRACTOR SHALL R POND. THIS SEDIMENT SEDIMENT HAS MIGRAT THE POND BOTTOM CO	OF THE SITE WORK AND UPON EMOVE ALL SEDIMENTS FROM TH REMOVAL SHALL INCLUDE THE EX ED TO ASSURE THAT THE NATUR MPACTION IS CRITICAL TO THE PE	HE SIDES AND BOTTO XISTING SOIL TO A DE AL SOIL PERCOLATION ERCOLATION OF THE N	M OF THE HOLDING EPTH TO WHICH THE I IS REESTABLISHED. VATURAL SOILS. THE		
OR SHALL REESTABLI DISKING, UNDERCUT, R METHODS AS NECESSA		OUT. RE-ESTABLISHM SAND, BOTTOM PLOWI	IENT WILL REQUIRE NG, AND\OR OTHER		
3. SWMF SIDE SLOPES	TO BE STABILIZED WITH SOD WITH	HIN 3 DAYS OF FINAL	. GRADE.		
		PRELIMIN	NARY NOT FO	R CONSTRUC	TION
ц <b>г.</b>					
LE:			A	JOB N	0. <u>13-034</u>
NG WITH TREE S	ME	THIS LINE DOES NOT EASURE ONE INCH IN ENGTH, THE SCALES	Joseph A. Al FLA. P.E. #57 MAR 192	day 7953 DRAWN CHECK	

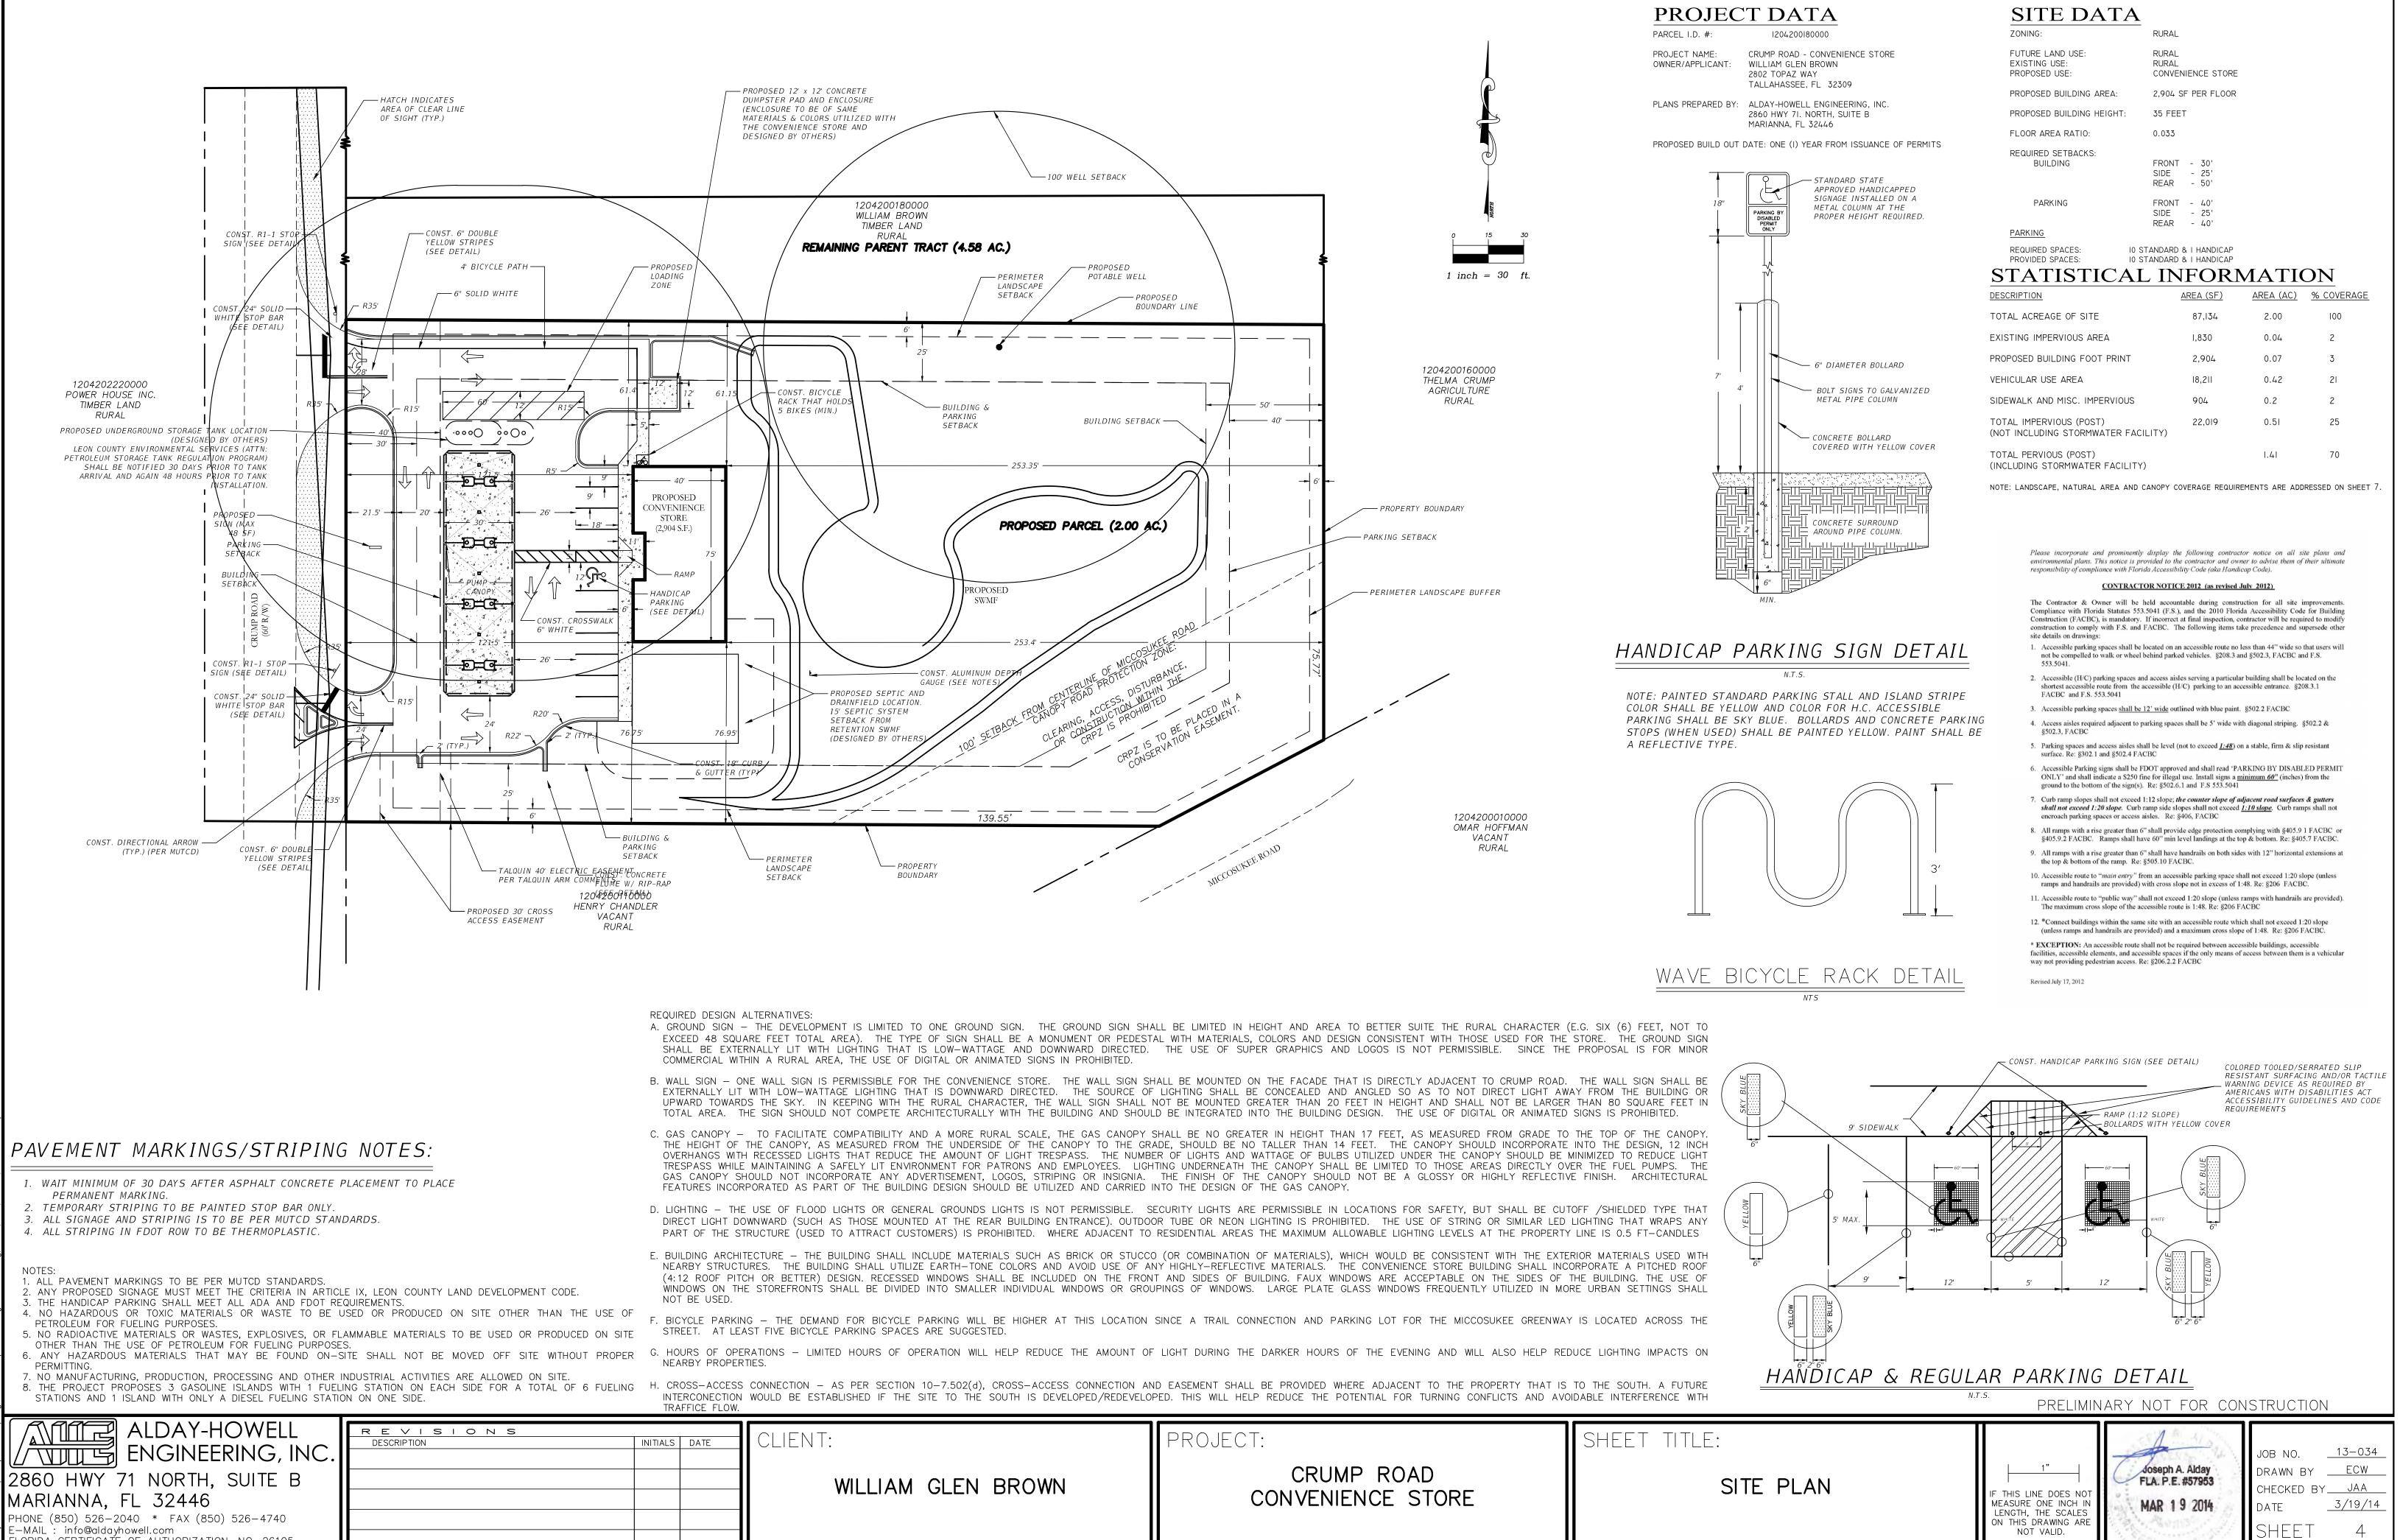


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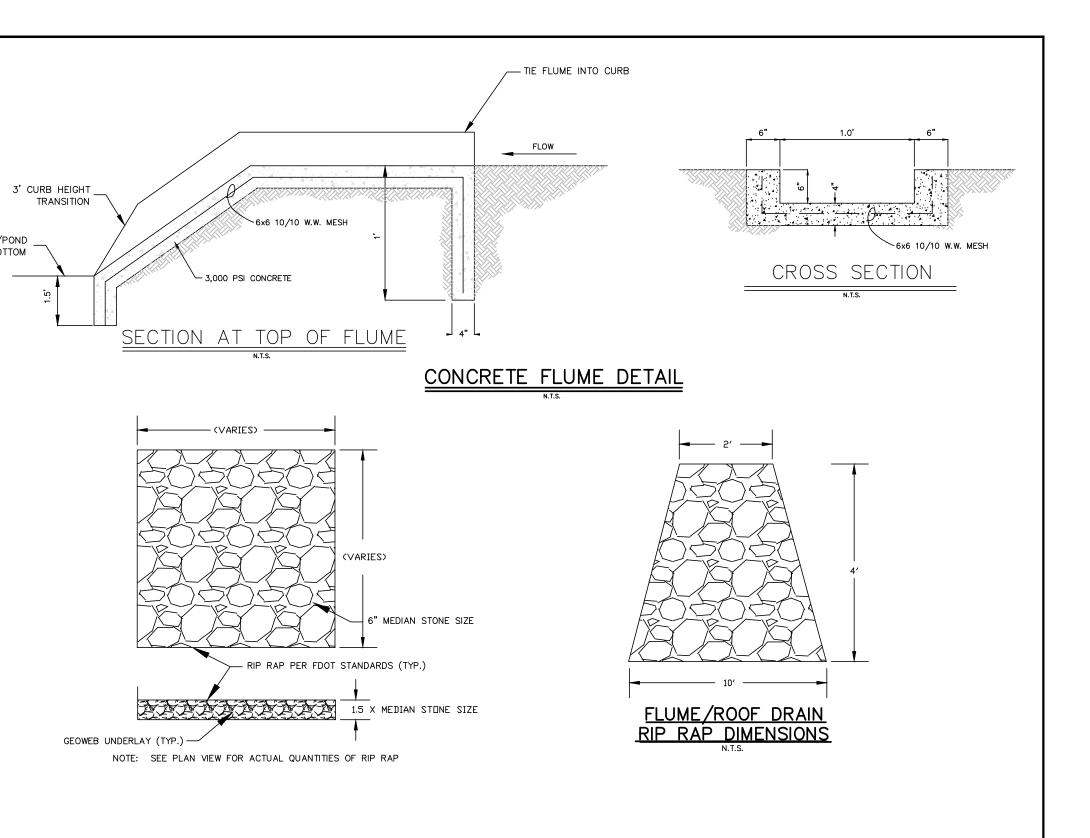
LORIDA CERTIFICATE OF AUTHORIZATION. NO. 26105

ZONING:	RURAL		
EXISTING USE:	RURAL RURAL CONVENIENCE STORE		
PROPOSED BUILDING AREA:	2,904 SF PER FLOOR		
PROPOSED BUILDING HEIGHT:	35 FEET		
FLOOR AREA RATIO:	0.033		
	FRONT - 30' SIDE - 25' REAR - 50'		
	FRONT - 40' SIDE - 25' REAR - 40'		
PARKING			
	NDARD & I HANDICAP NDARD & I HANDICAP		
STATISTICAL		<b>ATI</b>	ON
DESCRIPTION	AREA (SF)	AREA (AC)	% COVERAGE
TOTAL ACREAGE OF SITE	87,134	2.00	100
EXISTING IMPERVIOUS AREA	1,830	0.04	2
PROPOSED BUILDING FOOT PRINT	2,904	0.07	3
/EHICULAR USE AREA	18,211	0.42	21
SIDEWALK AND MISC. IMPERVIOUS	904	0.2	2
TOTAL IMPERVIOUS (POST) (NOT INCLUDING STORMWATER FACILI	22,019 TY)	0.51	25
TOTAL PERVIOUS (POST)		1.41	70

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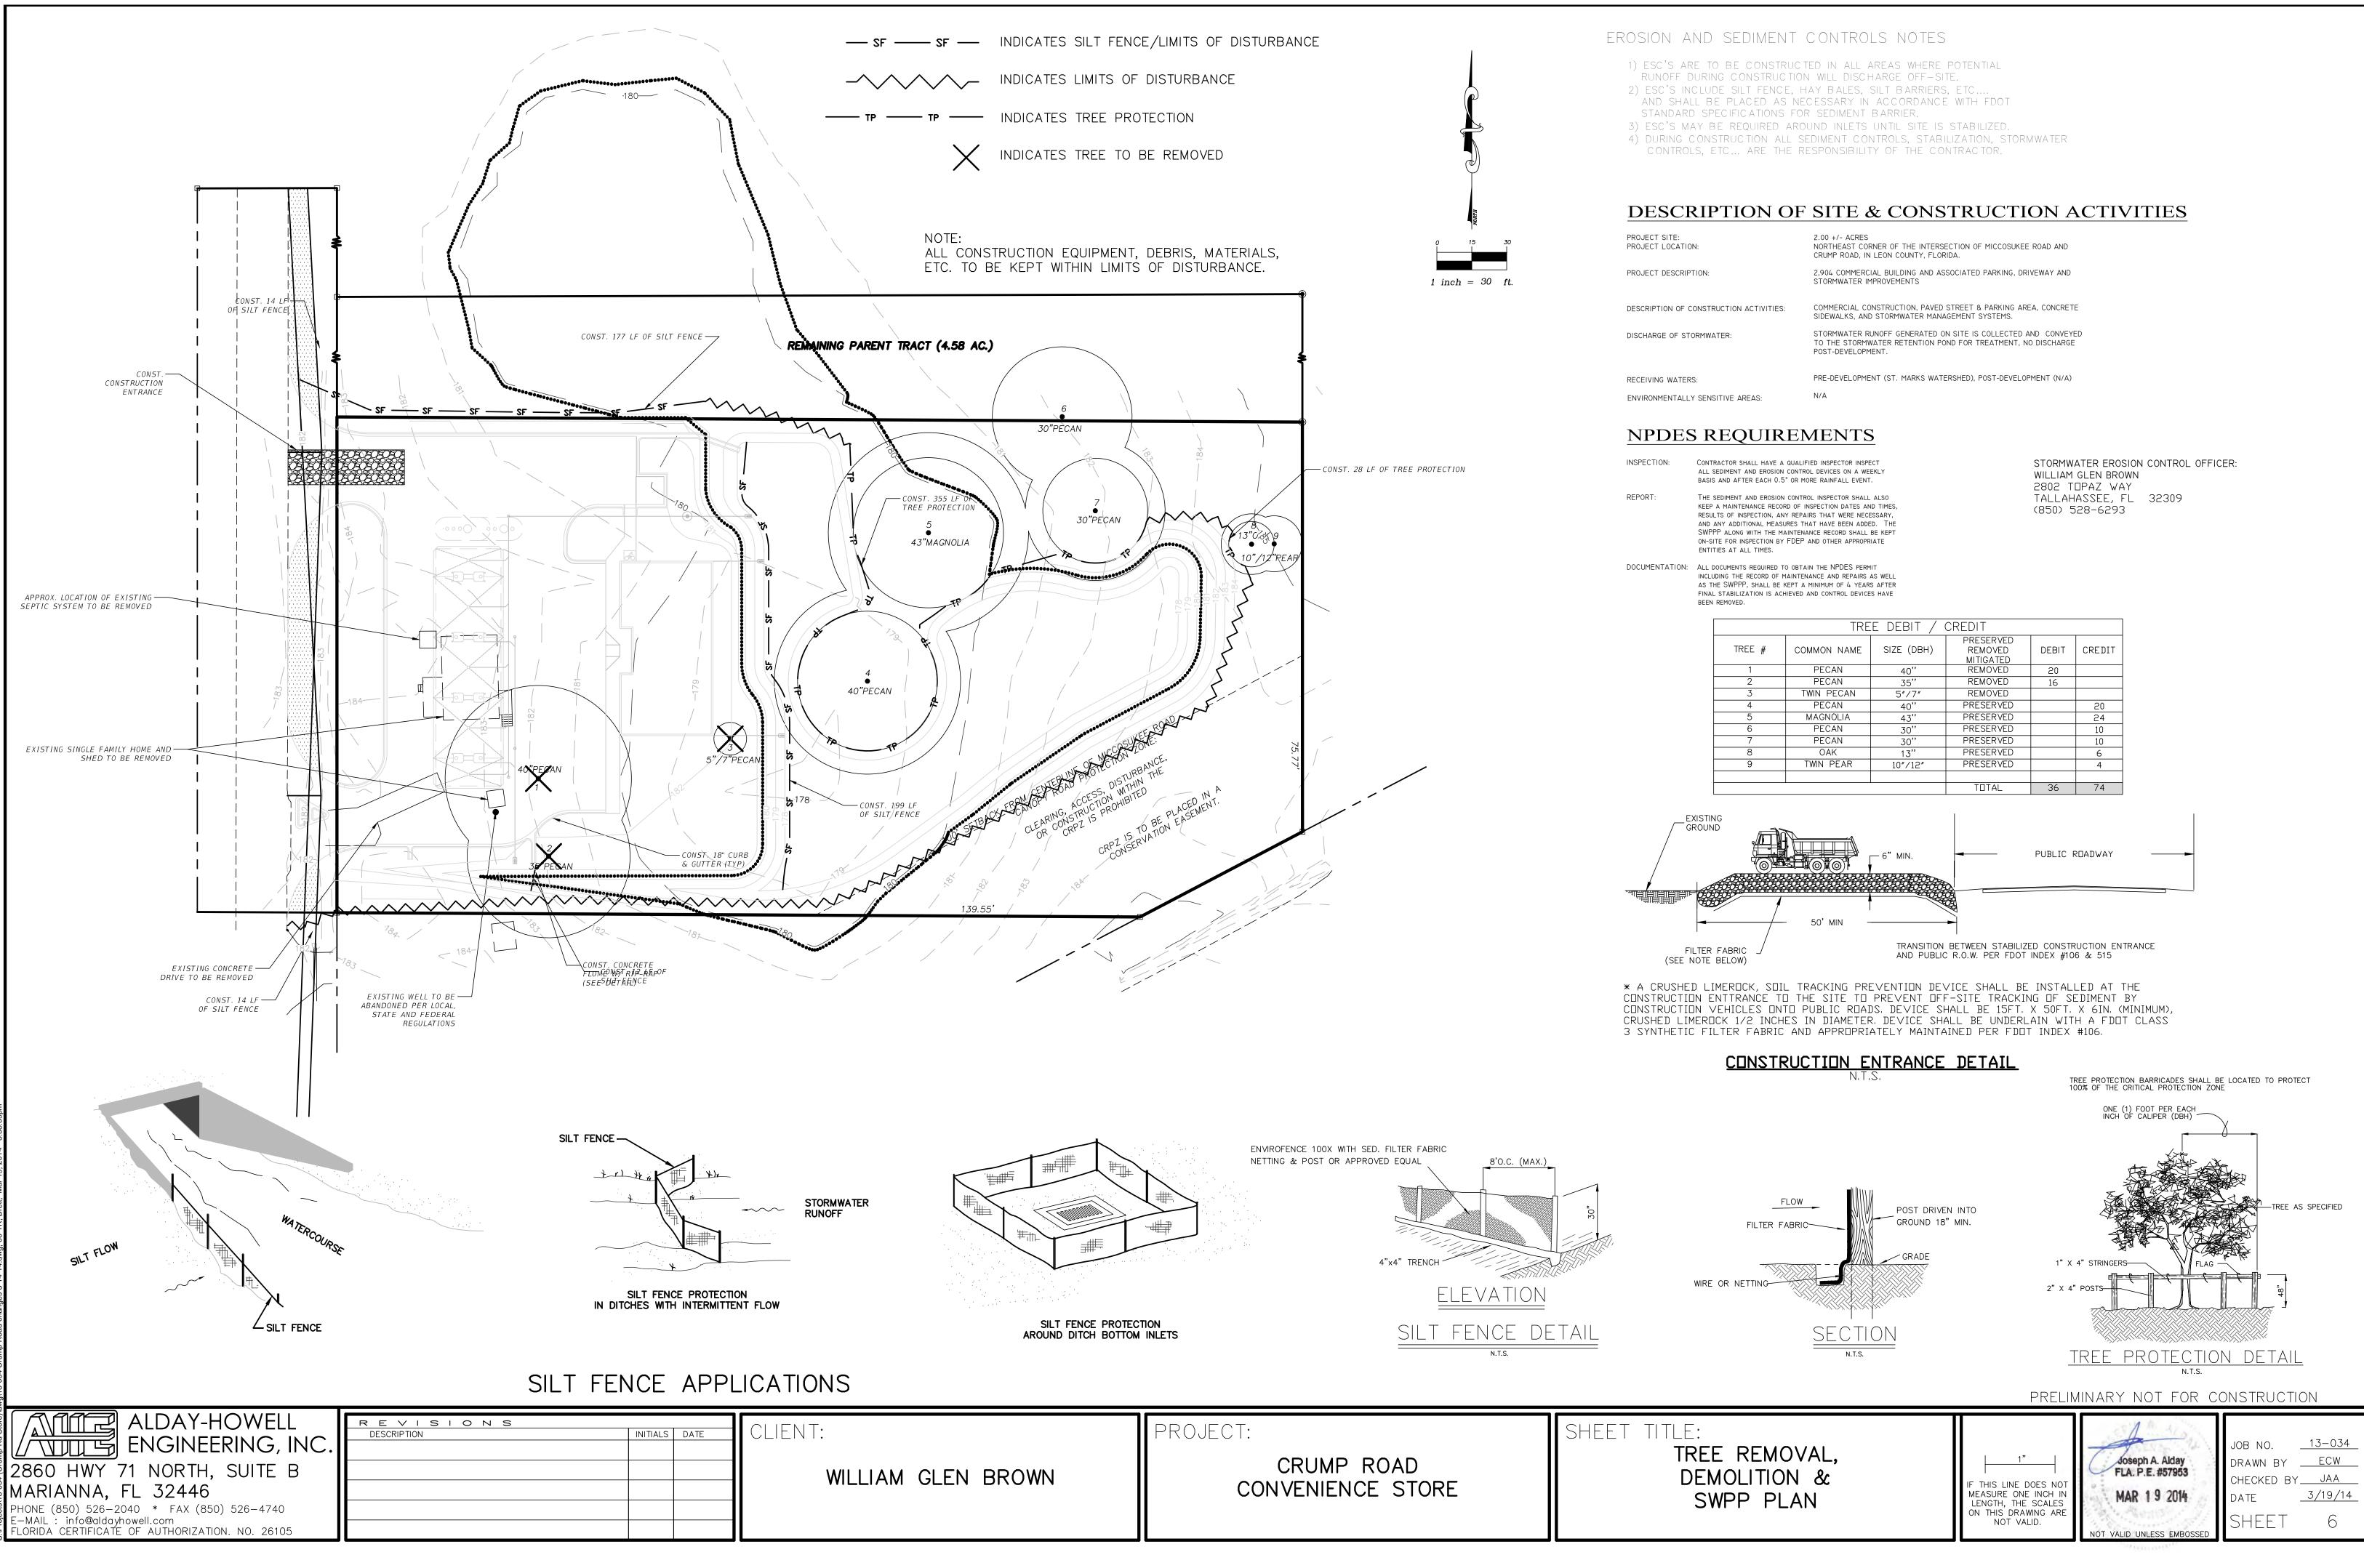


	N.T.S.	
NT: WILLIAM GLEN BROWN	PROJECT: CRUMP ROAD CONVENIENCE STORE	SHEET TI

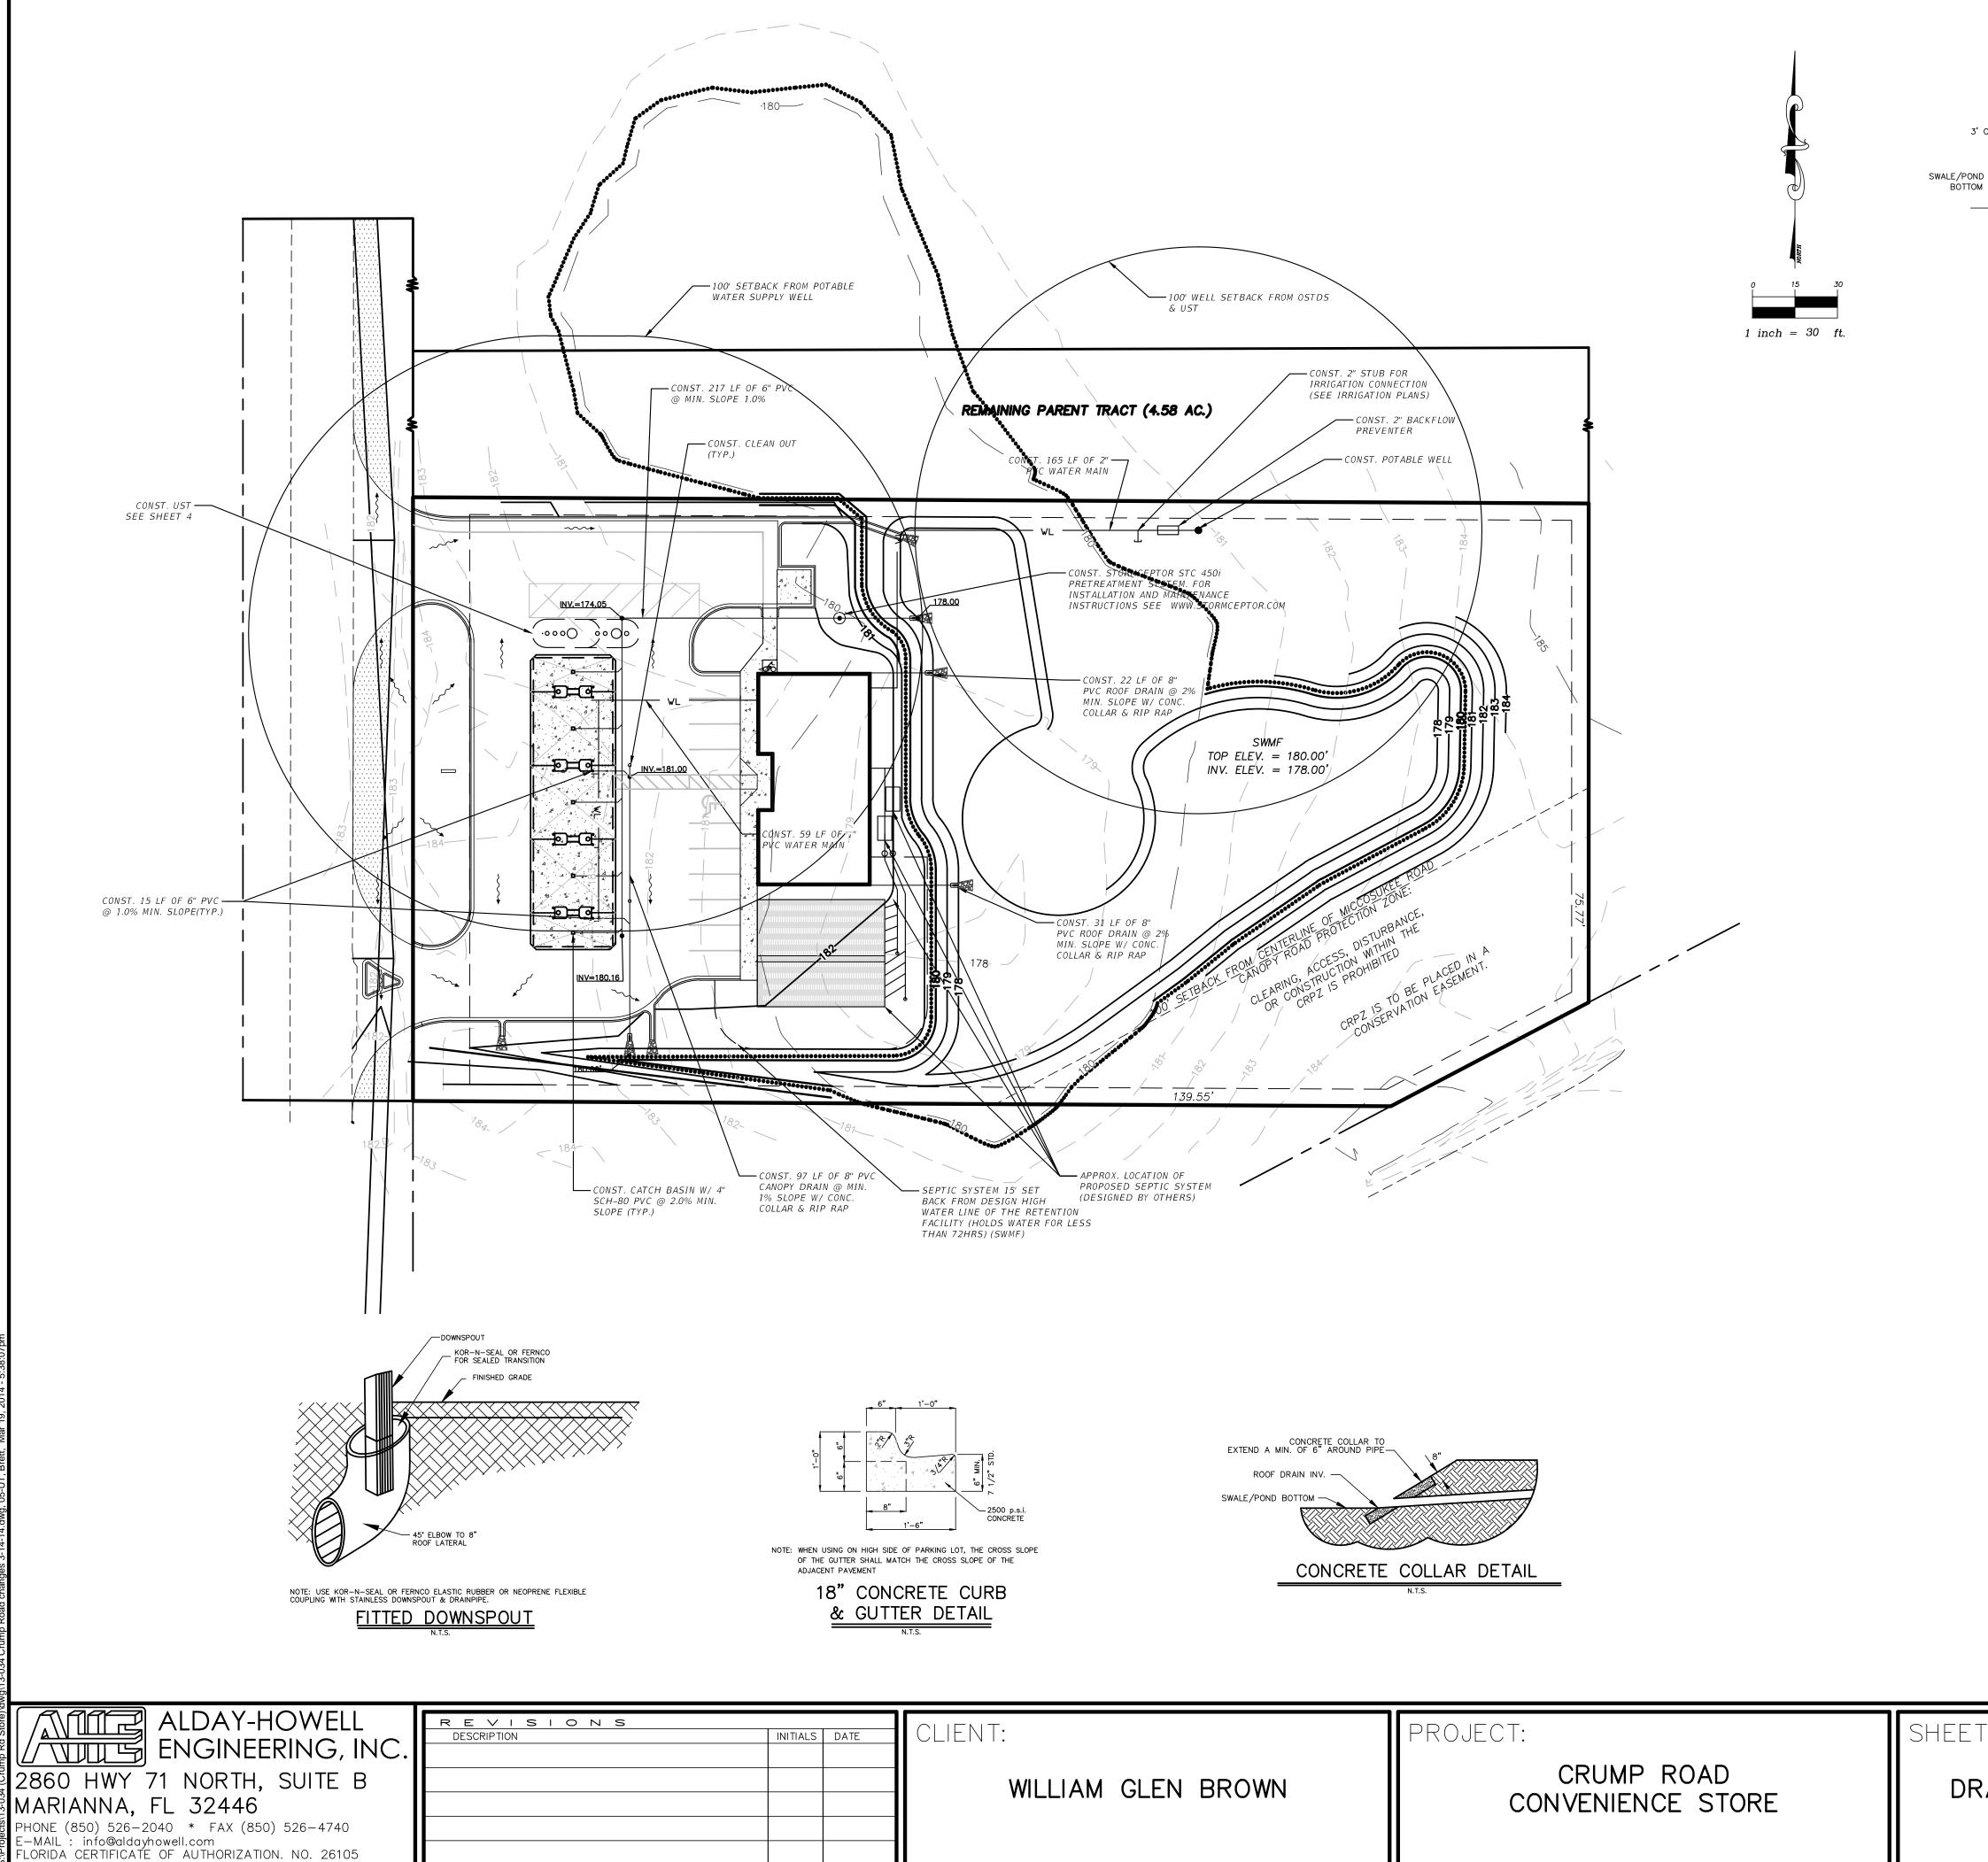

PRELIMINARY NOT FOR CONSTRUCTION

TLE:		A	JOB NO. <u>13–034</u>
IAGE AND UTILITY PLAN	IF THIS LINE DOES NOT MEASURE ONE INCH IN LENGTH, THE SCALES ON THIS DRAWING ARE NOT VALID.	Joseph A. Alday FLA. P.E. #57953 MAR 1 9 2014 NOT VALID UNLESS EMBOSSED	drawn by <u>ecw</u> checked by <u>jaa</u> date <u>3/19/14</u> SHEET 5



2.00 +/- ACRES NORTHEAST CORNER OF THE INTERSECTION OF MICCOSUKEE ROAD AND CRUMP ROAD, IN LEON COUNTY, FLORIDA.
2,904 COMMERCIAL BUILDING AND ASSOCIATED PARKING, DRIVEWAY AND STORMWATER IMPROVEMENTS
COMMERCIAL CONSTRUCTION, PAVED STREET & PARKING AREA, CONCRETE SIDEWALKS, AND STORMWATER MANAGEMENT SYSTEMS.
STORMWATER RUNOFF GENERATED ON SITE IS COLLECTED AND CONVEYED TO THE STORMWATER RETENTION POND FOR TREATMENT, NO DISCHARGE POST-DEVELOPMENT.

TREE DEBIT / CREDIT					
COMMON NAME	SIZE (DBH)	PRESERVED REMOVED MITIGATED	DEBIT	CREDIT	
PECAN	40"	REMOVED	20		
PECAN	35''	REMOVED	16		
TWIN PECAN	5″/7″	REMOVED			
PECAN	40''	PRESERVED		20	
MAGNOLIA	43''	PRESERVED		24	
PECAN	30''	PRESERVED		10	
PECAN	30"	PRESERVED		10	
OAK	13"	PRESERVED		6	
TWIN PEAR	10″/12″	PRESERVED		4	
	COMMON NAME PECAN PECAN TWIN PECAN PECAN MAGNOLIA PECAN PECAN OAK	COMMON NAMESIZE (DBH)PECAN40"PECAN35"TWIN PECAN5"/7"PECAN40"MAGNOLIA43"PECAN30"PECAN30"OAK13"	COMMON NAMESIZE (DBH)PRESERVED REMOVED MITIGATEDPECAN40''REMOVEDPECAN35''REMOVEDTWIN PECAN5"/7"REMOVEDPECAN40''PRESERVEDPECAN40''PRESERVEDPECAN30''PRESERVEDPECAN30''PRESERVEDPECAN30''PRESERVEDOAK13''PRESERVED	COMMON NAMESIZE (DBH)PRESERVED REMOVED MITIGATEDDEBITPECAN40"REMOVED20PECAN35"REMOVED16TWIN PECAN5"/7"REMOVED16PECAN40"PRESERVED16PECAN40"PRESERVED16PECAN30"PRESERVED16PEC	

	Charles Ch


### LANDSCAPE NOTES:

- CONTRACTOR SHALL LOCATE ALL UNDERGROUND UTILITIES PRIOR TO COMMENCING INSTALLATION OF LANDSCAPING.
- 2. CONTRACTOR SHALL INSTALL ONLY PLANTS GRADED FLORIDA #1, AS SET FORTH IN THE FLORIDA DEPARTMENT OF AGRICULTURE "GRADES AND STANDARDS FOR NURSERY PLANTS" PART 1 AND 2 AND REVISIONS, AND WHICH MEET OR EXCEED THE SIZES INDICATED IN THE PLANTING SCHEDULE, DETAILS, OR AS SPECIFIED IN THE PLAN. ALL PLANT MATERIAL SHALL BE HEALTHY, WELL PROPORTIONED, AND DISEASE FREE.
- 3. CONTRACTOR SHALL INSTALL AN AUTOMATIC UNDERGROUND IRRIGATION SYSTEM TO PROVIDE 100% COVERAGE OF ALL NEWLY PLANTED PLANTS AND GRASSED AREAS. ALL IRRIGATION LINES INSTALLED SHALL NOT IMPACT CPZ OF PROTECTED TREES. CONTRACTOR SHALL SUBMIT SHOP DRAWING PLANS OF PROPOSED SYSTEM TO OWNER FOR APPROVAL PRIOR TO CONSTRUCTION.
- 4. IRRIGATION SLEEVES REQUIRED UNDER PARKING OR DRIVE AREAS SHALL BE INSTALLED PRIOR TO CONSTRUCTION OF THE LIMEROCK BASE.
- 5. ALL PLANTS, LANDSCAPE MATERIALS, AND WORKMANSHIP ARE SUBJECT TO APPROVAL BY THE OWNER.
- 6. ALL PLANTS AND MATERIAL INSTALLATION SHALL MEET ALL LEON COUNTY REQUIREMENTS OR STANDARDS AS WELL AS INDUSTRY STANDARDS FOR LANDSCAPE CONSTRUCTION.
- 7. CONTRACTOR SHALL BE RESPONSIBLE FOR WATERING PLANTS AND GRASS UNTIL IRRIGATION SYSTEM HAS BEEN INSTALLED AND ACCEPTED BY THE OWNER.
- 8. AFTER ACCEPTANCE BY THE OWNER, THE OWNER SHALL BE RESPONSIBLE FOR MAINTAINING ALL LANDSCAPING REQUIRED BY THE ENVIRONMENTAL PERMIT IN PERPETUITY.
- 9. ALL PLANTING BEDS SHALL BE MULCHED WITH 2 INCHES OF PINE STRAW AFTER PLANTS HAVE BEEN INSTALLED.

	REVISIONS		
	DESCRIPTION INITIA	LS DATE	
2860 HWY 71 NORTH, SUITE B			-
MARIANNA, FL 32446			
PHONE (850) 526–2040 * FAX (850) 526–4740			
E-MAIL : info@aldayhowell.com FLORIDA CERTIFICATE OF AUTHORIZATION. NO. 26105			


- PLANTING AREA AND LACED WITH NON-COMPACTED 'FRIABLE' TOPSOIL.
- DRESSING WITH PINE STRAW.
- AT AMOUNTS SPECIFIED BY MANUFACTURER.
- ACCORDANCE TO MANUFACTURER'S SPECIFICATIONS.
- AND MATERIALS AS SHOWN ON THE PLANS, SCHEDULE, OR DETAILS.
- INSTALLED MATERIALS.
- OWNER, ENGINEER OF RECORD, AND ENVIRONMENTAL INSPECTOR. NO EXCEPTIONS!
- 17. A MINIMUM IRRIGATION REQUIREMENT HOSE BIBS ARE TO BE PLACED AT A MAXIMUM DISTANCE OF 100' FROM PROPOSED LANDSCAPING.
- COUNTY PRIOR TO CONSTRUCTION.


2 M PH

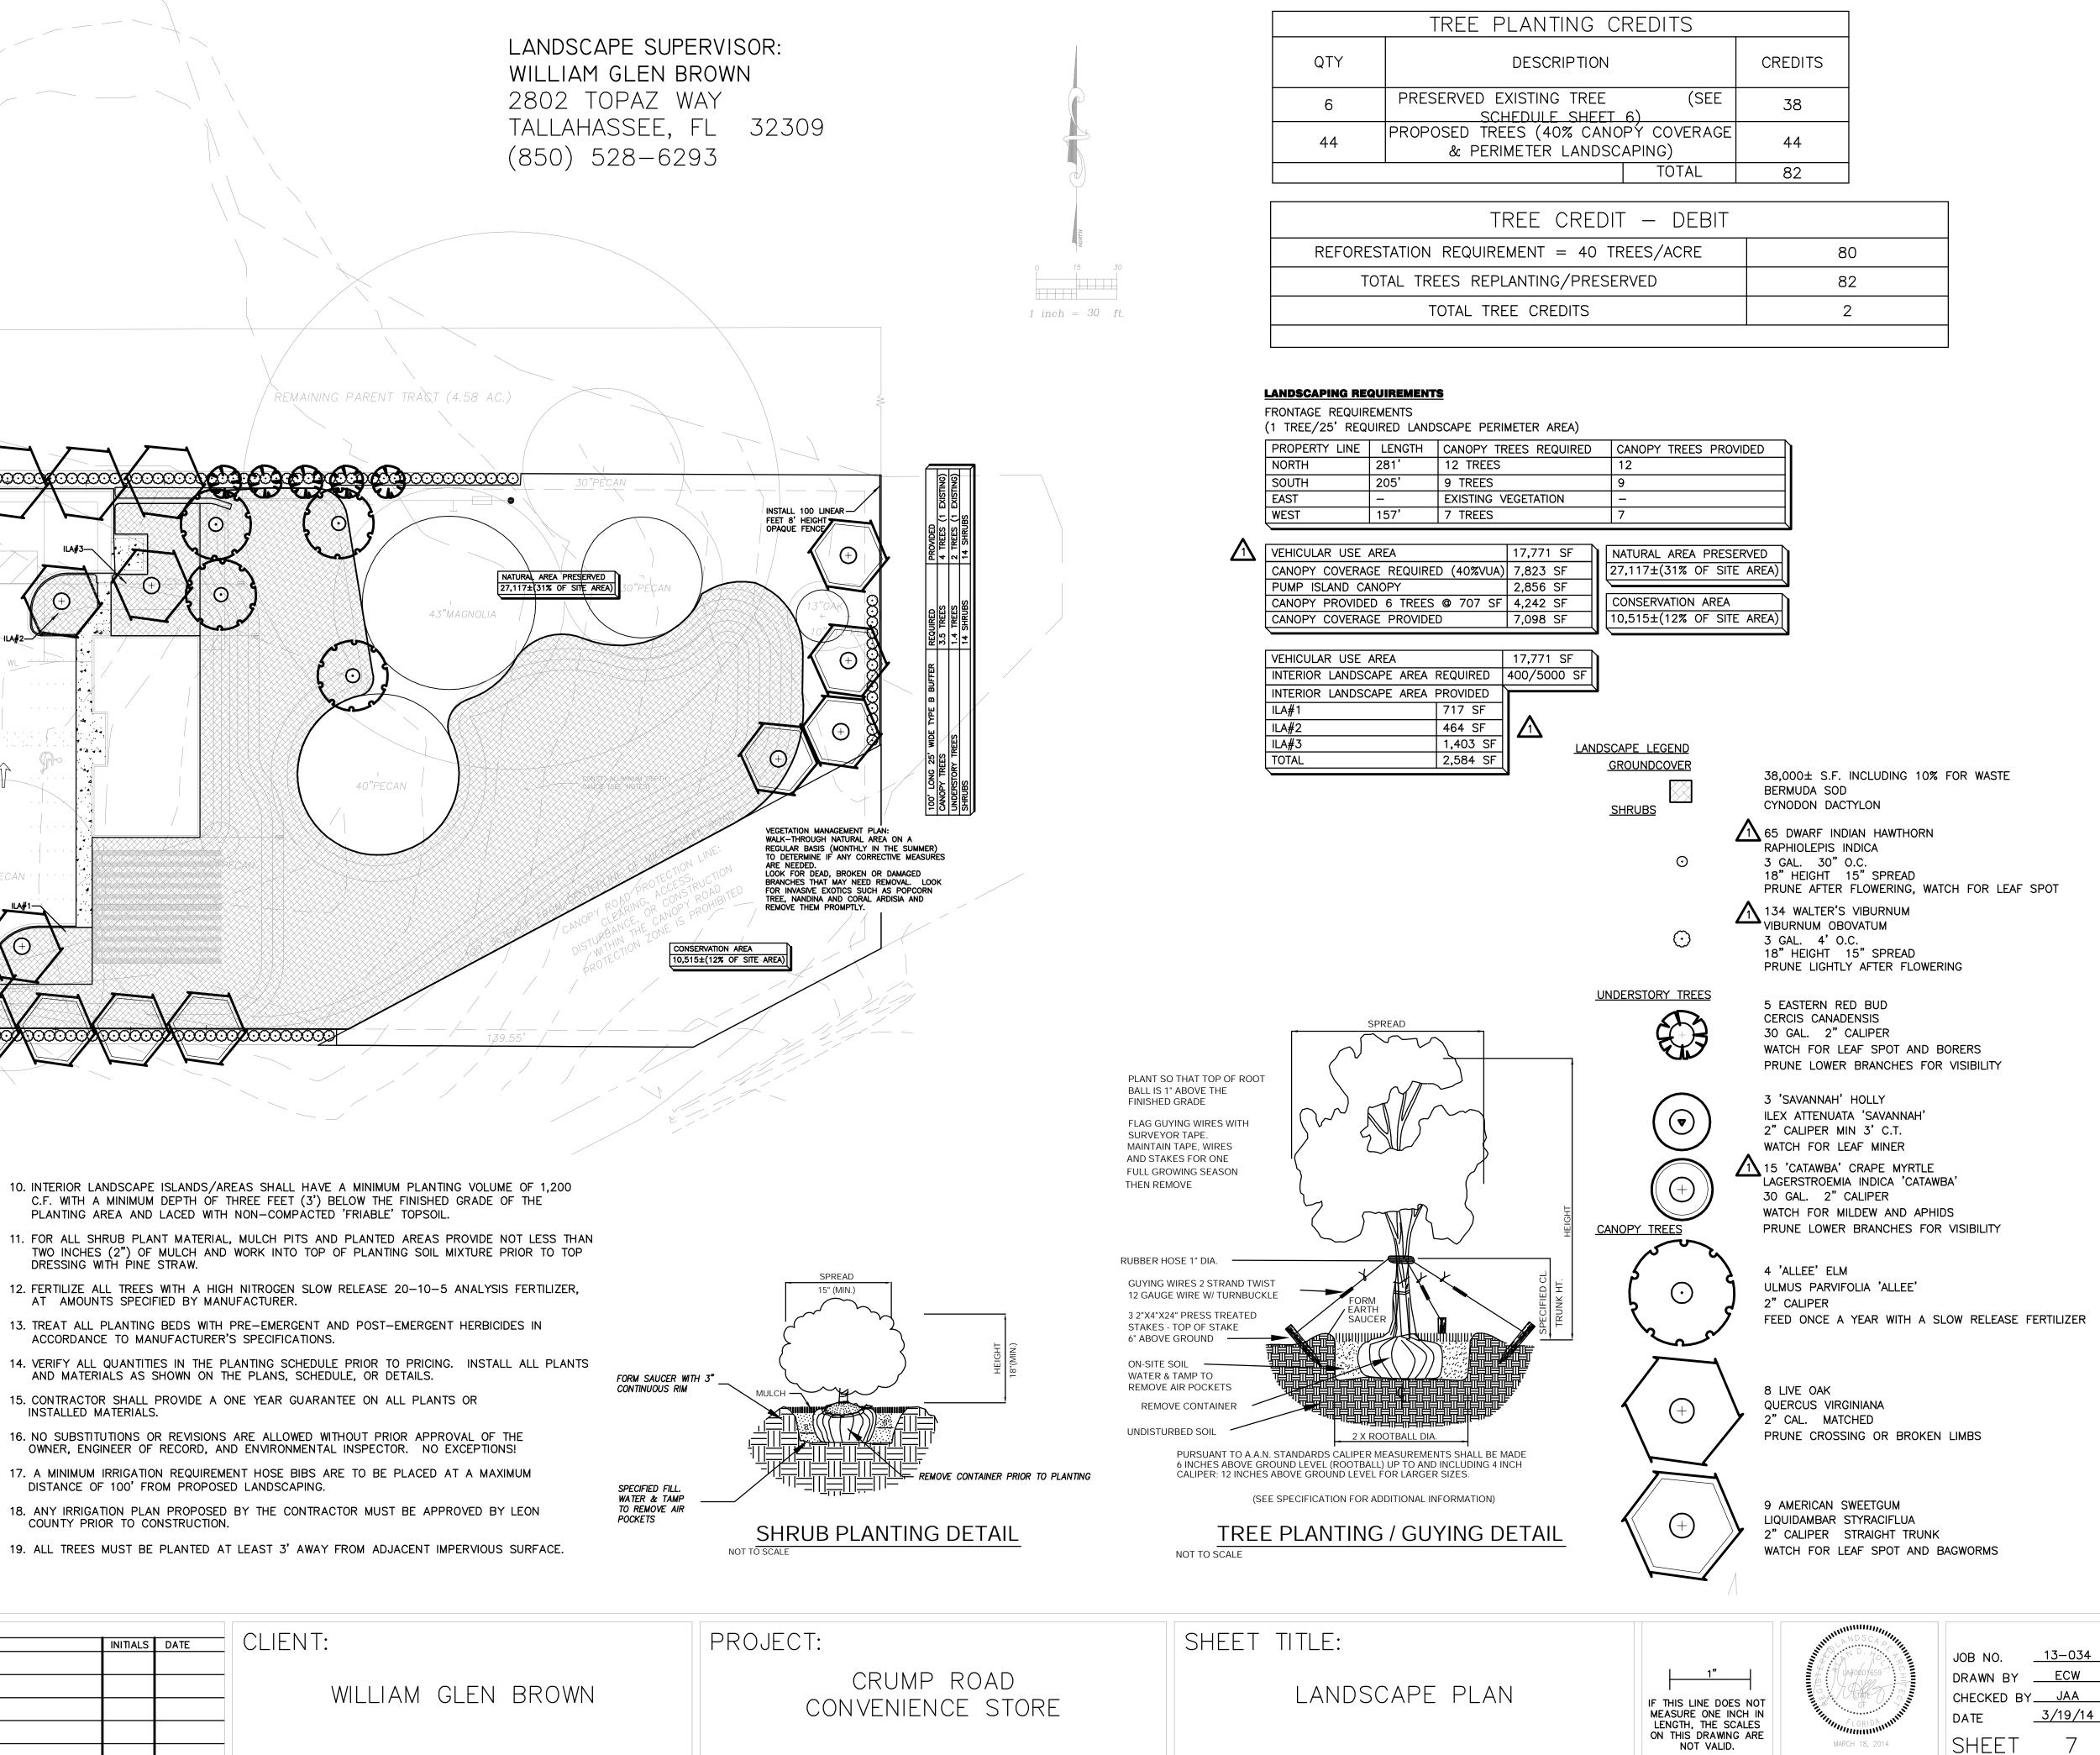

TREE PLANTING CREDITS			
QTY	DESCRIPTION	CREDITS	
6	PRESERVED EXISTING TREE (SEE SCHEDULE SHEET 6)	38	
44	SCHEDULE SHEET 6) PROPOSED TREES (40% CANOPY COVERAGE & PERIMETER LANDSCAPING)	44	
TOTAL		82	
TREE CREDIT – DEBIT			
REFORESTATION REQUIREMENT = $40 \text{ TREES/ACRE}$		8	0
TOTAL TREES REPLANTING/PRESERVED		82	
TOTAL TREE CREDITS		2	2

NOT VALID UNLESS EMBOSSED

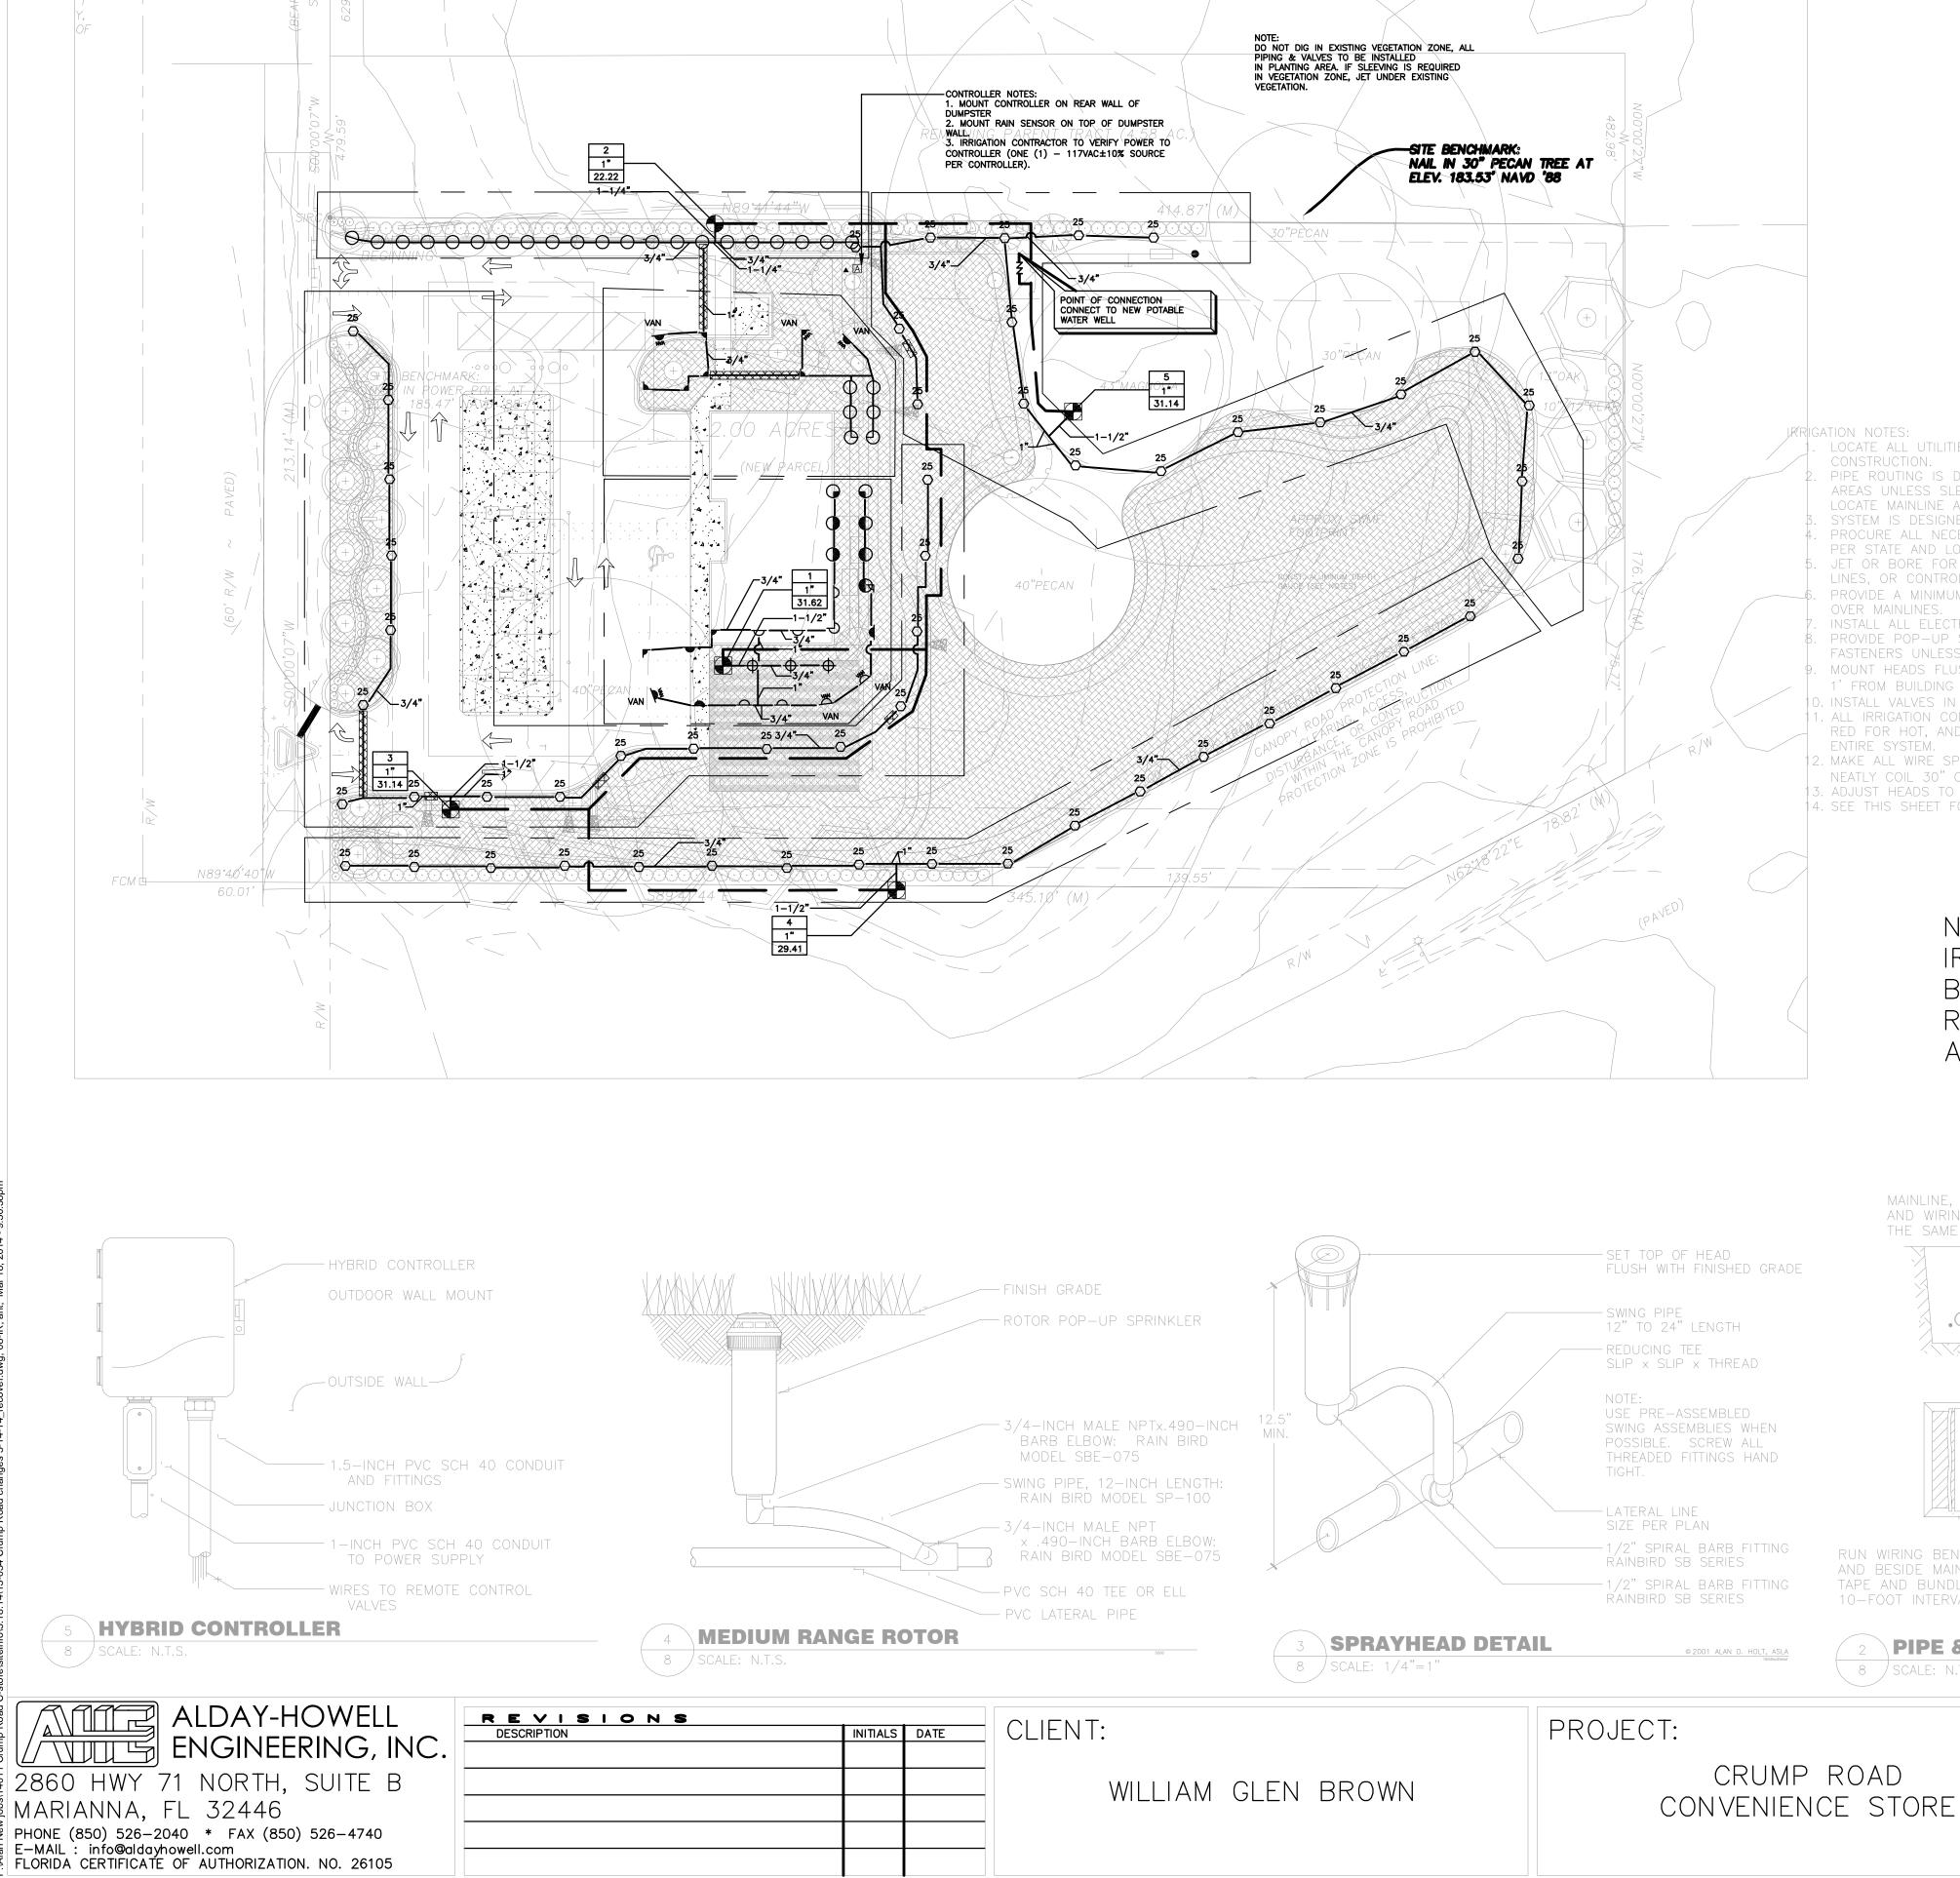

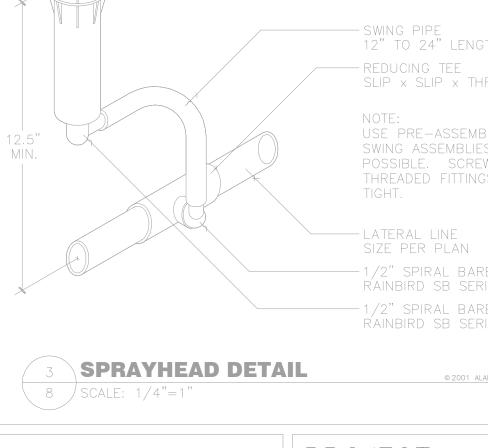

 $\bigcirc$ .0 RUN WIRING BENEATH-ALL SOLVENT WELD-AND BESIDE MAINLINE. PLASTIC PIPING TO TAPE AND BUNDLE AT

8 / SCALE: N.T.S.

**PIPE & WIRE TRENCHING** 

MAINLINE, LATERAL, MAINLINE

and wiring in THE SAME TRENCH

# NOTE: IRRIGATION PLAN TO BE REVISED TO REFLECT FINAL APPROVED SITE PLAN

ENTIRE SYSTEM. 2. MAKE ALL WIRE SPLICES WITH WATERPROOF SPLICE KITS RATED FOR DIRECT BURIAL. NEATLY COIL 30" OF SLACK WIRE IN VALVE BOX. 3. ADJUST HEADS TO MAXIMIZE COVERAGE AND MINIMIZE OVERSPRAY. 14. SEE THIS SHEET FOR INSTALLATION DETAILS.


1' FROM BUILDING WALLS. 0. INSTALL VALVES IN 15" BOXES WITH TAMPER RESISTANT LIDS. 1. ALL IRRIGATION CONTROL WIRE TO BE 14-GAUGE WIRE. PROVIDE WHITE FOR COMMON, RED FOR HOT, AND A SPARE BLUE WIRE PARALLEL TO COMMON THROUGHOUT THE

OVER MAINLINES. INSTALL ALL ELECTRICAL SERVICE TO MEET LOCAL CODES. . PROVIDE POP-UP SPRINKLERS ONLY. MOUNT SPRINKLERS ON POLY PIPE WITH BARBED FASTENERS UNLESS OTHERWISE SPECIFIED IN PROVIDED DETAILS. ). MOUNT HEADS FLUSH WITH FINISHED GRADE. INSTALL HEADS 6" OFF ALL SIDEWALKS AND

PER STATE AND LOCAL CODES. JET OR BORE FOR SLEEVING WHERE NECESSARY TO ACCOMMODATE LATERAL LINES, MAIN LINES, OR CONTROL WIRE. PROVIDE A MINIMUM 12" COVER OVER LATERAL LINES AND A MINIMUM OF 18" COVER

AREAS UNLESS SLEEVING IS INDICATED. ROUTE PIPING TO AVOID TREE LOCATIONS. LOCATE MAINLINE AND VALVE BOXES WITHIN PROPERTY LINES. SYSTEM IS DESIGNED TO OPERATE AT 32 GPM AT 70 PSI. . PROCURE ALL NECESSARY PERMITS TO COMPLETE INSTALLATION OF IRRIGATION SYSTEM

REGATION NOTES: 1. LOCATE ALL UTILITIES BEFORE DIGGING. PROTECT ALL UTILITIES FROM DAMAGE DURING

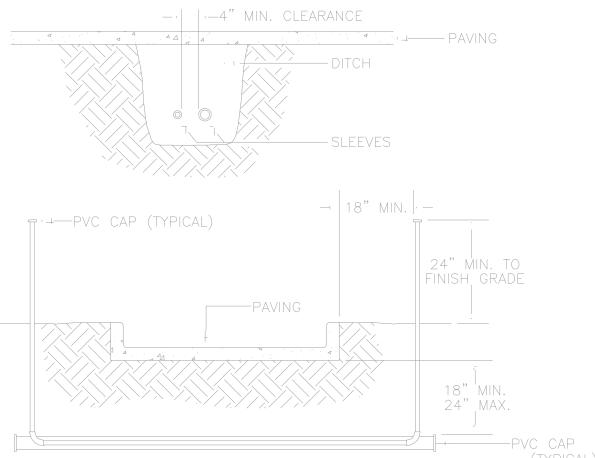

- NOTES: 1. ALL PVC IRRIGATION SLEEVES TO BE SCHEDULE 40 PIPE.
- 3. WHERE THERE IS MORE THAN ONE SLEEVE, EXTEND THE SMALLER SLEEVE

MODEL (RAINBIRD UNLESS OTHERWISE NOTED) GALLONS PER MINUTE

26

.52

.39

.72

1.30

0.65

1.30

1.95

2.60

.92

1.85

.92-1.85

1.73 @ 35 PSI

- TO 24-INCHES MINIMUM ABOVE FINISH GRADE.

- 4. MECHANICALLY TAMP TO 95% PROCTOR.

### **SLEEVING DETAIL**

1806-8Q

1806-8H

1806-10Q

1806-10H

1806-12VAN

1806-12Q

1806-12H

1806–12TQ

1806–12F

1806–15Q

1806-15H

100-PGA

RAIN SENSOR

RSD-BEX

5004-MPR-25-H

7 STATION CONTROLLER

" ELECTRIC REMOTE CONTROL VALVE

ESP-4M FOUR STATION BASE WITH (1) THREE STATION MODULE

1-1/2" REDUCED PRESSURE PRINCIPLE BACKFLOW PREVENTER

1-1/2" 1-1/2" ELECTRIC REMOTE CONTROL VALVE 150-PGA

🖌 👝 VAN | 1806–15VAN

8 / SCALE: N.T.S.

IRRIGATION SCHEDULE QUANTITY KEY

25

2

5

2

1

5

1

3

4

7

3

53

4

1

1

1

 $\square$ 

 $|\ominus|$ 

Р

5

 $|\oplus|$ 

◯ 25

1"


Z

CONDUIT WIRE W/O CONDUIT

wiring in

- TIE A 24–INCH LOOP IN $\longrightarrow$
- OF DIRECTION OF 30° HAVE BEEN MADE.
- IRRIGATION LEGEND \_\_\_\_\_ SIZE AS NOTED VALVE NUMBER 1 1-1/2" VALVE SIZE 35 GALLONS PER MINUTE
- SHEET TITLE:
  - IRRIGATION PLAN

IF THIS LINE DOES NOT MEASURE ONE INCH IN LENGTH, THE SCALES ON THIS DRAWING ARE NOT VALID.

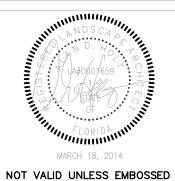

JOB NO.	13-034
DRAWN BY	ECW
CHECKED BY	JAA
DATE	3/19/14
SHEET	8

- - SCHEDULE 40 MAINLINE CLASS 200 LATERAL LINE 6" SCHEDULE 40 SLEEVE UNLESS NOTED OTHERWISE